## 2022-COA-170 (RP) 806-826 DR. MARTIN LUTHER KING, JR. STREET





## ST CLAIR APARTMENTS NEW CONSTRUCTION

12-07-2022



PROJECT LOCATION:
806-826 DR MARTIN LUTHER KING JR STREET
INDIANAPOLIS, IN 46202



1 VICINITY MAP

NOT TO SCALE

ST CLAIR APARTME
ST CLAIR APARTME
NEW CONSTRUCTIC
NEW CONSTRUCTIC
NEW CONSTRUCTIC
806 - 826 DR. MART
INDIANAPOLIS, IN
INDIANAPOLIS, IN
ST CLAIR APARTME
3 JR STREET

DATE: 12-07-2022 DRAWN BY: Author

COVER

T CLAIR APARTME OIL

EW CONSTRUCTIC

36 - 826 DR. MARTI

MONIAPOLIS IN MINAPOLIS IN

S N S

REVISIONS:
# Date Desc.

SET STATUS

PROJECT: #22110

DATE: 08-22-2022

DRAWN BY: Author

DRAWN BY: Author

EXTERIOR
ELEVATIONS





SET STATUS

PROJECT: #22110 DATE: 08-22-2022 DRAWN BY: Author EXTERIOR ELEVATIONS





3 ST CLAIR ELEVATION

SCALE: 1/8" = 1'-0"

0 4' 8' 16'



BACK ALLEY ELEVATION

SCALE: 1/8" = 1'-0"

9
4'
8'
16'



SET STATUS

PROJECT: #22110
DATE: 08-22-2022
DRAWN BY: Author

DATE: 08-22-2022
DRAWN BY: Author

EXTERIOR
ELEVATIONS

A203

QUAD AND DUPLEX SIDE ELEVATION

SCALE: 1/8" = 1'-0"

9\_4\*\*\*

16'





QUAD SIDE ELEVATION

SCALE: 1/8" = 1'-0"

0 4' 8' 16'



SET STATUS


PROJECT: #22110

DATE: 08-22-2022

DRAWN BY: Author

EXTERIOR ELEVATIONS

A204

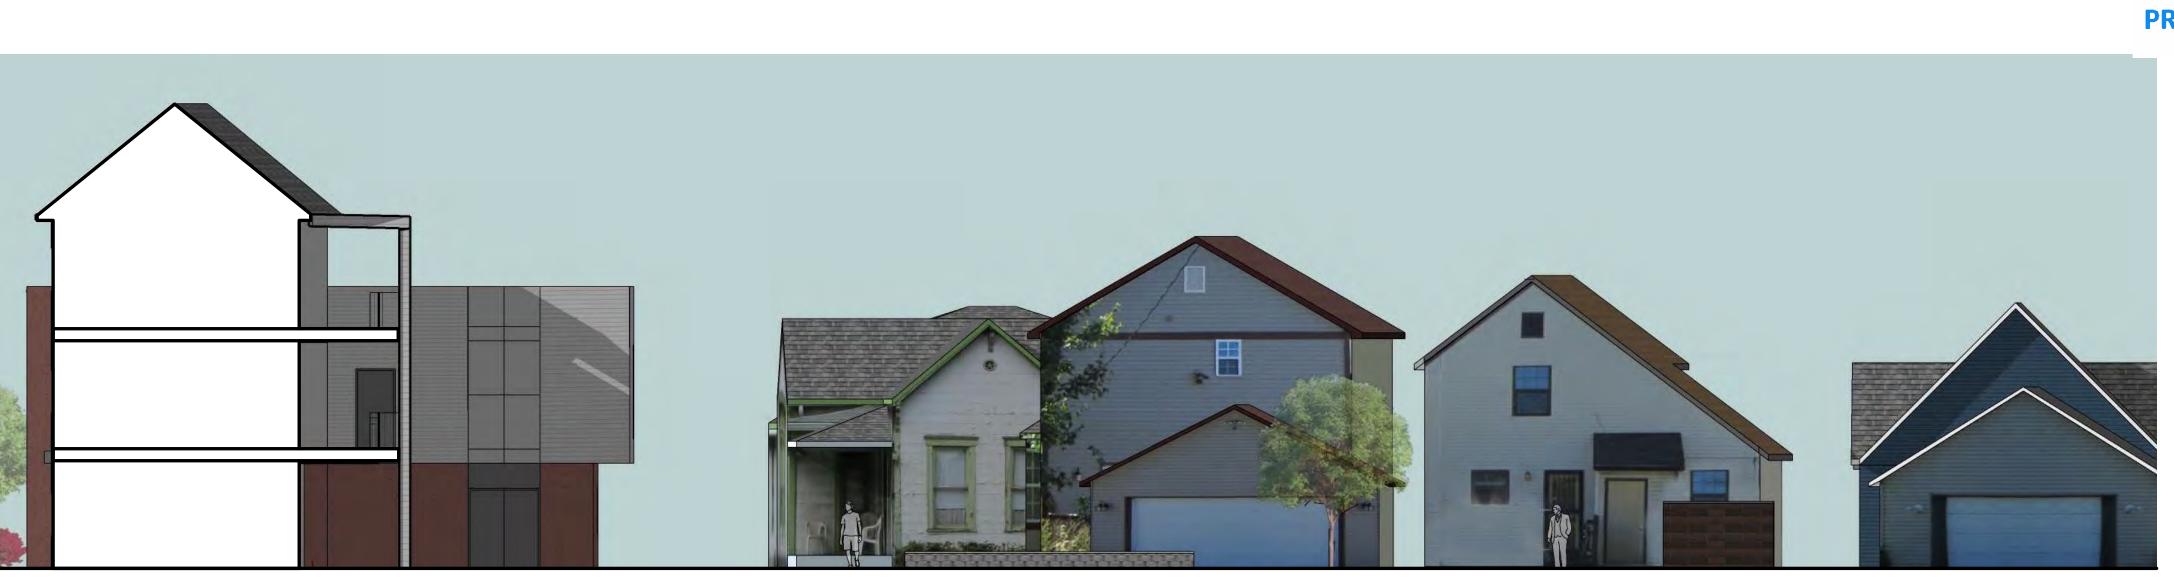

2 INTERIOR WEST ELEVATION

SCALE: 1/8" = 1'-0"

16'



PROJECT: #22110

DATE: 08-22-2022

DRAWN BY: Author

3D

VISUALIZATION

A301



PERSPECTIVE 2

NOT TO SCALE



SET STATUS

PROJECT: #22110

DATE: 08-22-2022

DRAWN BY: Author

3D VISUALIZATION



PROJECT: #22110 DATE: 08-22-2022 DRAWN BY: Author

3D VISUALIZATION



SET STATUS

PROJECT: #22110

DATE: 08-22-2022

DRAWN BY: Author

3D VISUALIZATION

A304



PERSPECTIVE 6

NOT TO SCALE



T DATE/TIME:11/17/2022 1:50:51 PN

#

SET STATUS

PROJECT: #22110

DATE: 08-22-2022


DRAWN BY: Author

MEMORIAL VIEWS







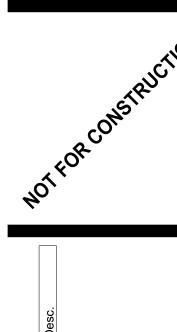

SET STATUS PROJECT: #22110 DATE: 08-22-2022 DRAWN BY: Author


MEMORIAL VIEWS









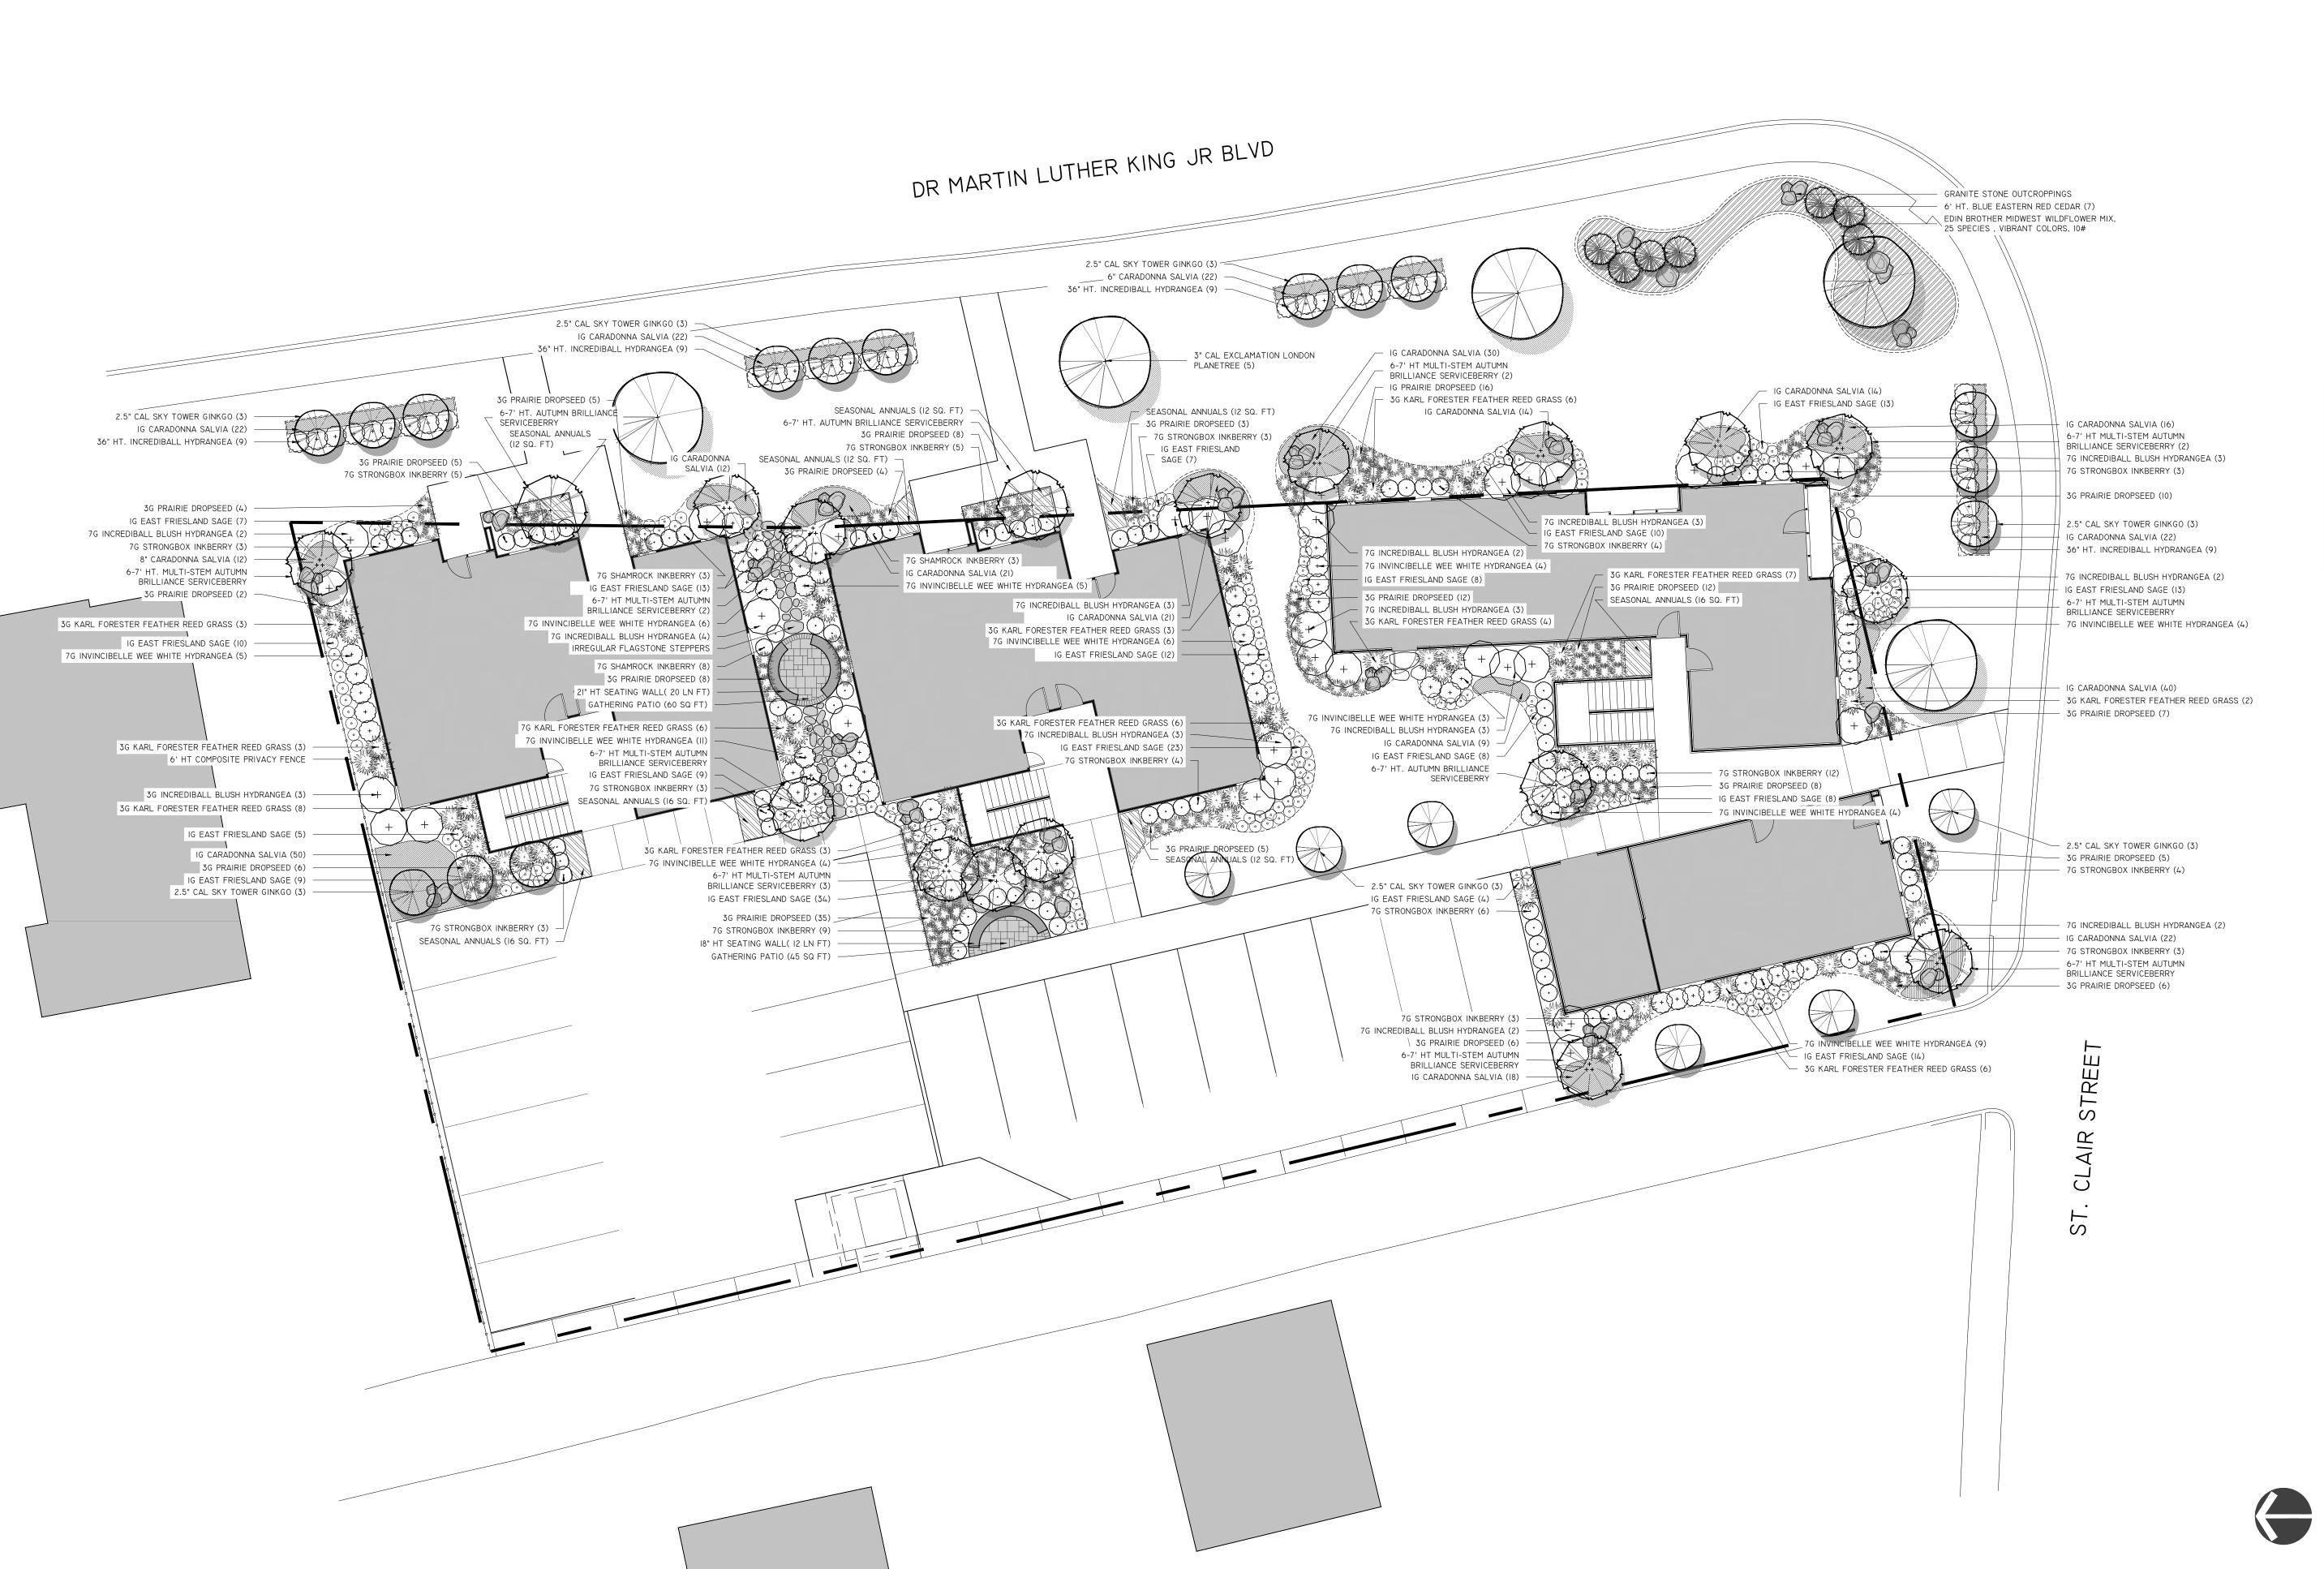



Project

ST. CLAIR

APARTMENTS

806-826 Dr. Martin
Luther King Jr. St.
Indianapolis, IN 46202

August 19, 2022

Team

REED + EVERETT
301 E. Carmel Dr.
Suite F200
reedeverett.com
(317) 564-4781

RECEIVED

**NOVEMBER 21, 2022** 

INDIANAPOLIS HISTORIC
PRESERVATION COMMISSION

Key Plan

10

Graphic Scale 1"= 10'-0" Sheet Size 24"x36"

\_\_\_\_\_

SILK

Revision

SCHEMATIC PLAN

SHEET 1 OF 1

1.00

3 - STORY BUILDING FIRST FLOOR








PROJECT #22110 11.10.22

3-STORY BUILDING SECOND FLOOR

<u>A106</u>

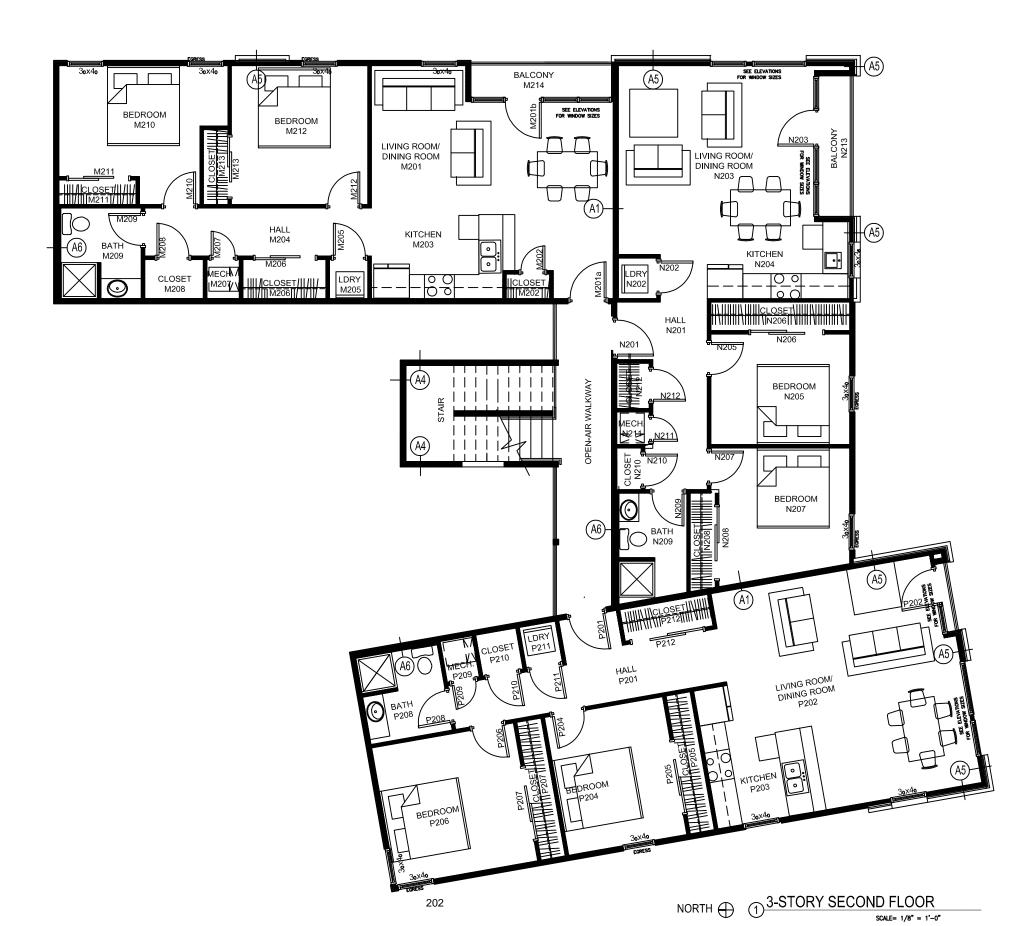




PROJECT: #22110

11.10.22 3-STORY BUILDING THIRD FLOOR



PROJECT: #22110

11.10.22 FIRST FLOOR PLAN QUAD BUILDING

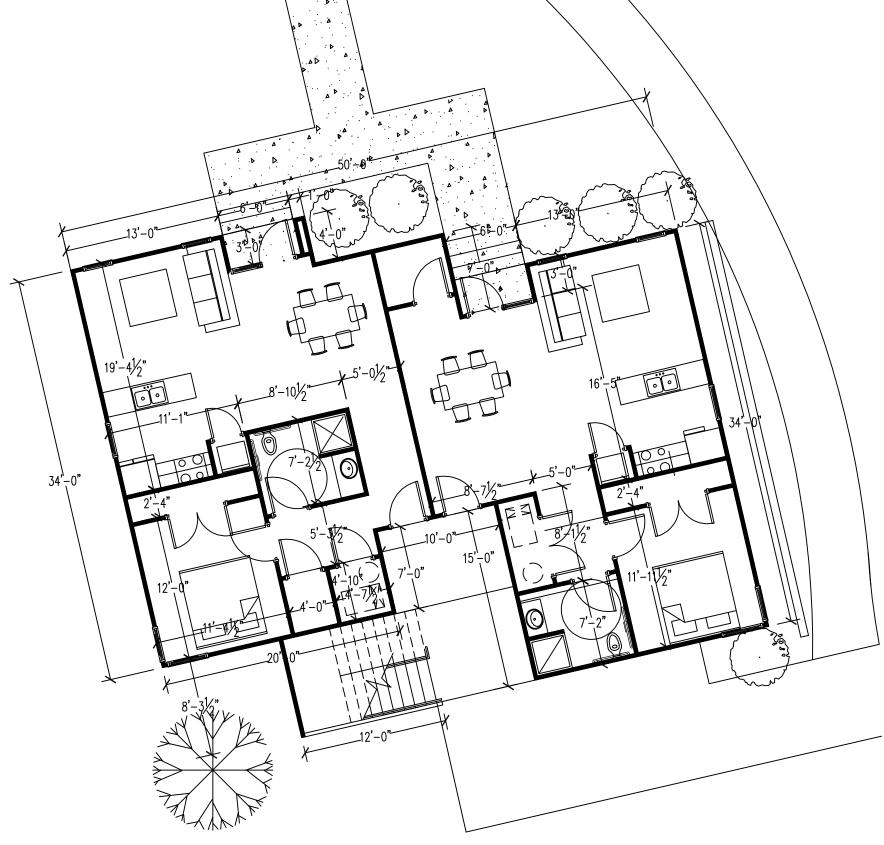

PROJECT: #22110

11.10.22

SECOND FLOOR PLAN QUAD BUILDING



## 2022-COA-435 (MCD) 33 NORTH CAPITOL AVENUE




## COURT STREET GARAGE EXTERIOR RENOVATION

IHPC REVIEW PACKAGE
JULY 2022


#### DKGR

10 W MARKET ST SUITE 800 INDIANAPOLIS, IN 46204 P: 317.614.0053 F: 317.632.3662 DKGR@DKGRAR.COM

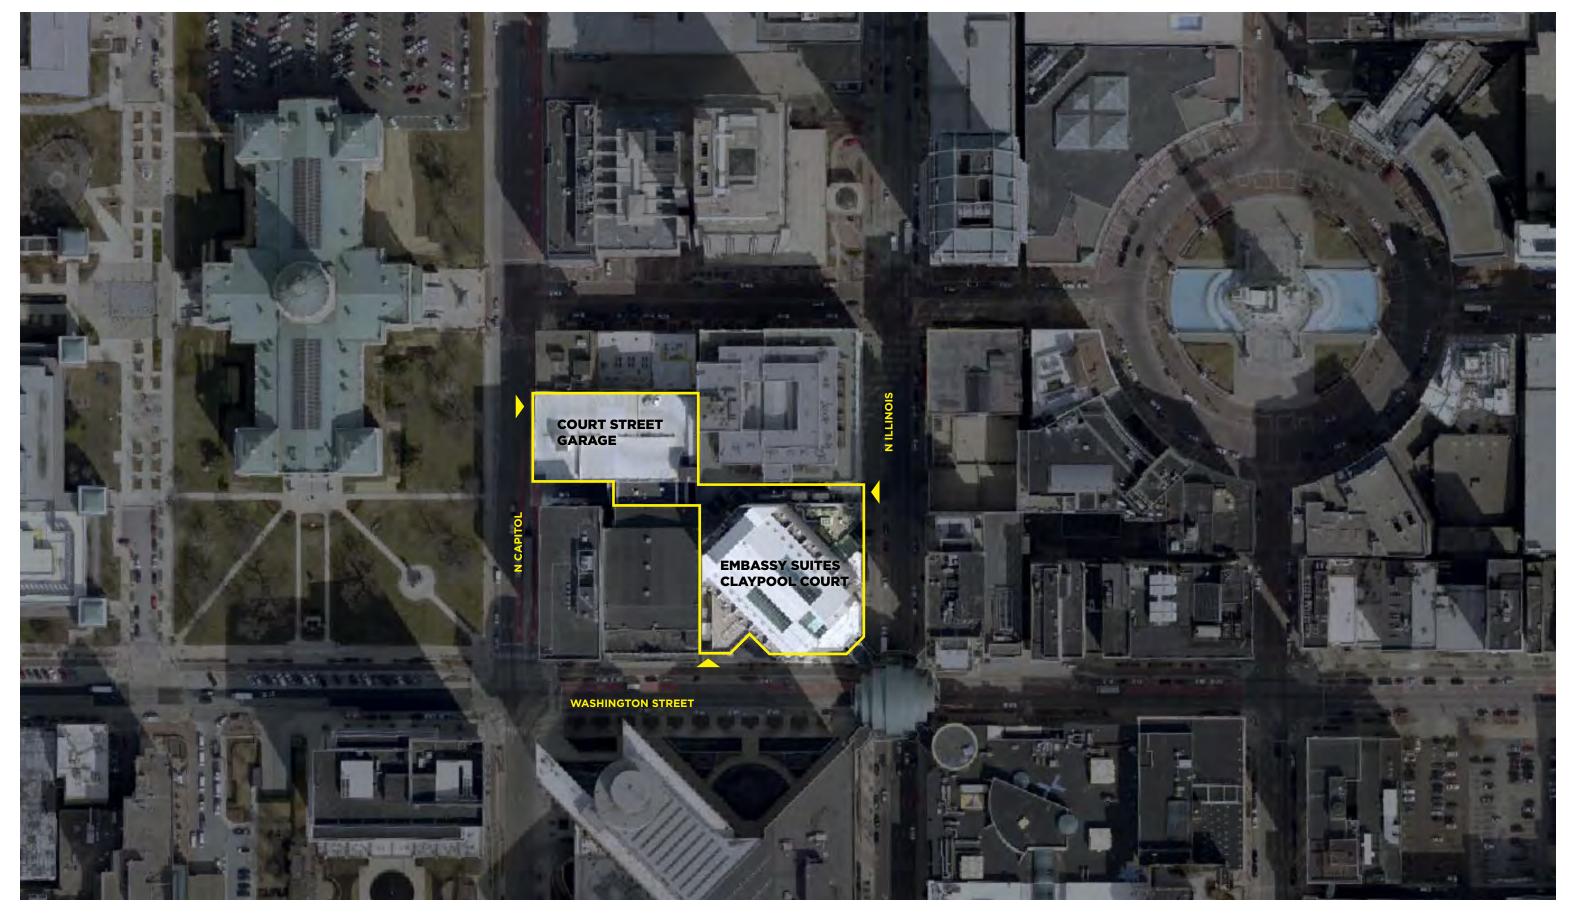





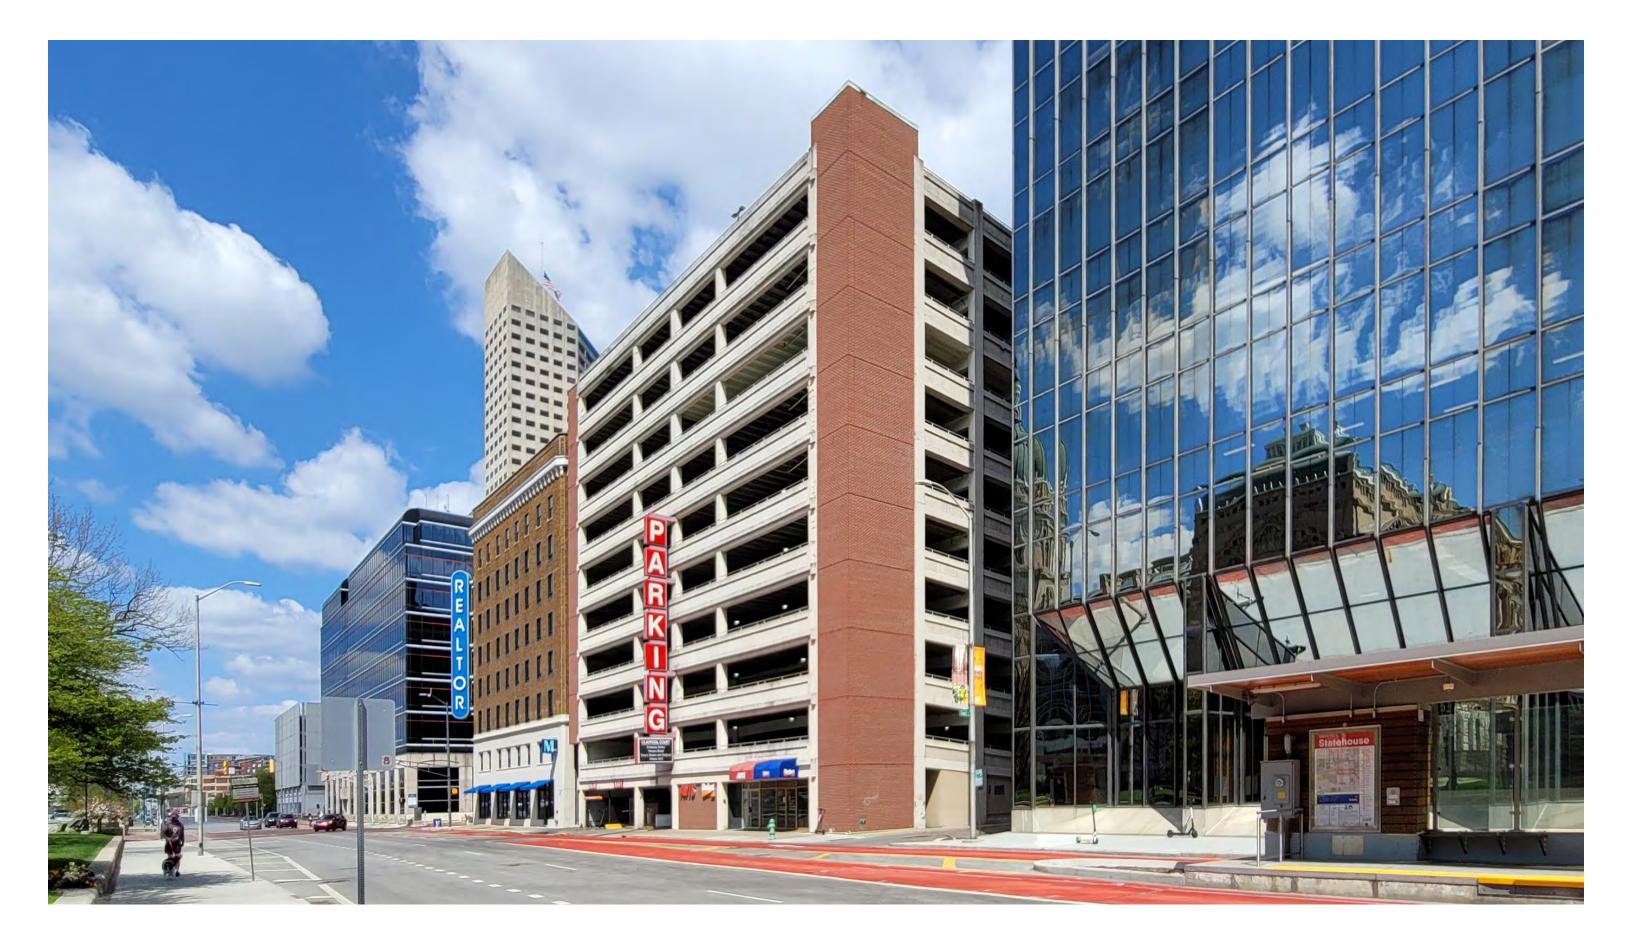




DKGr






DKGr

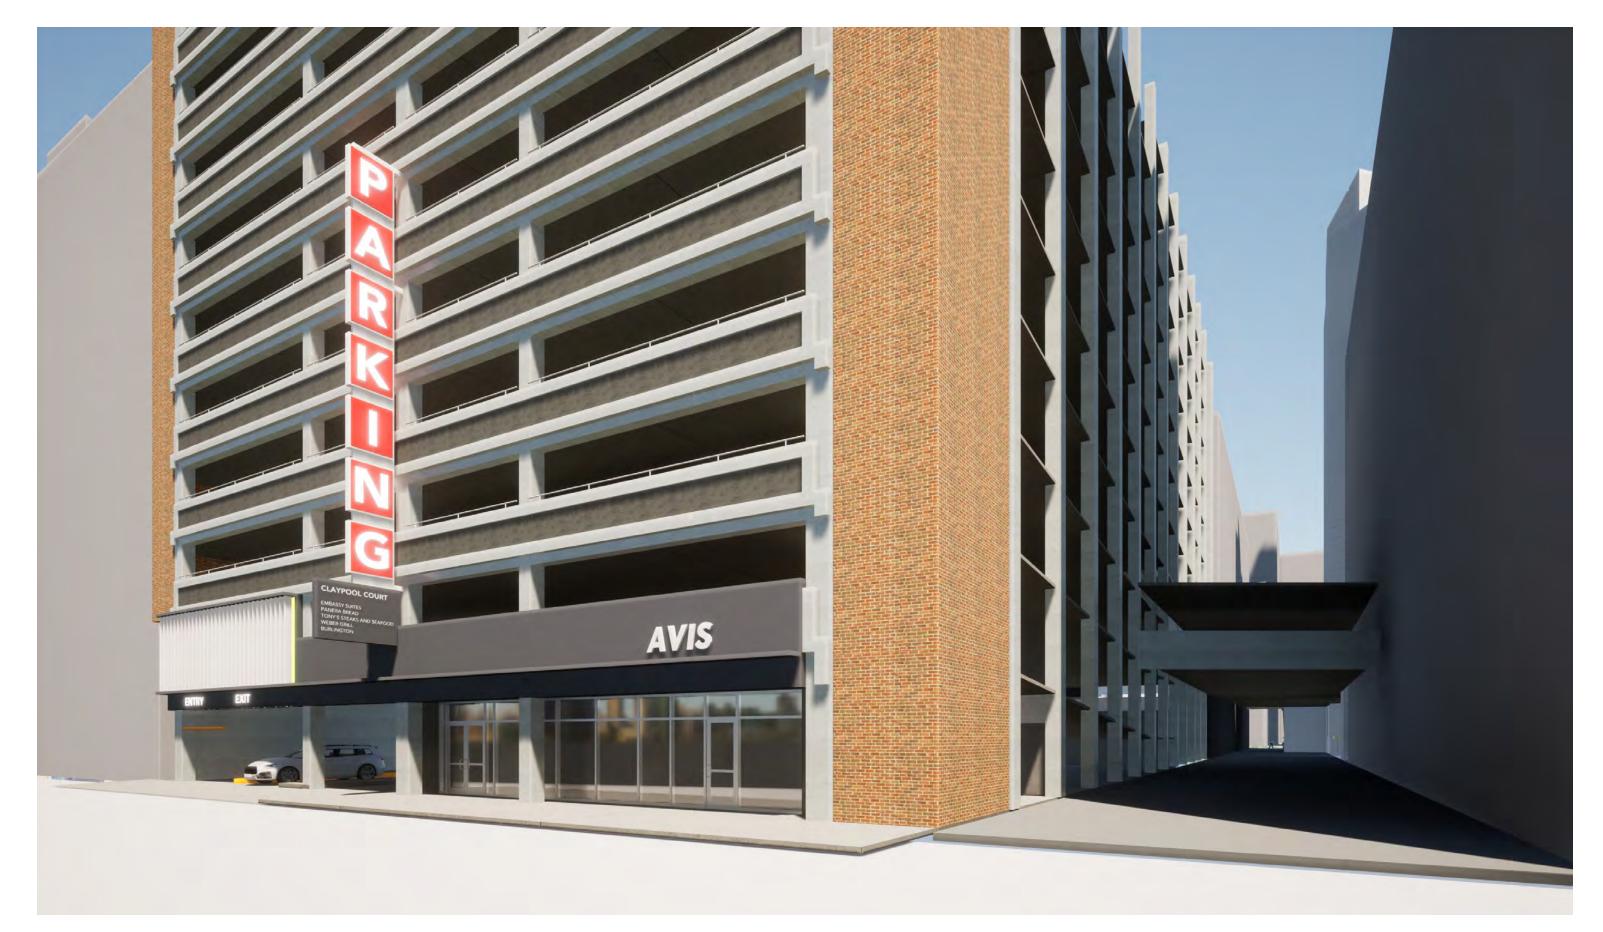



DKGr

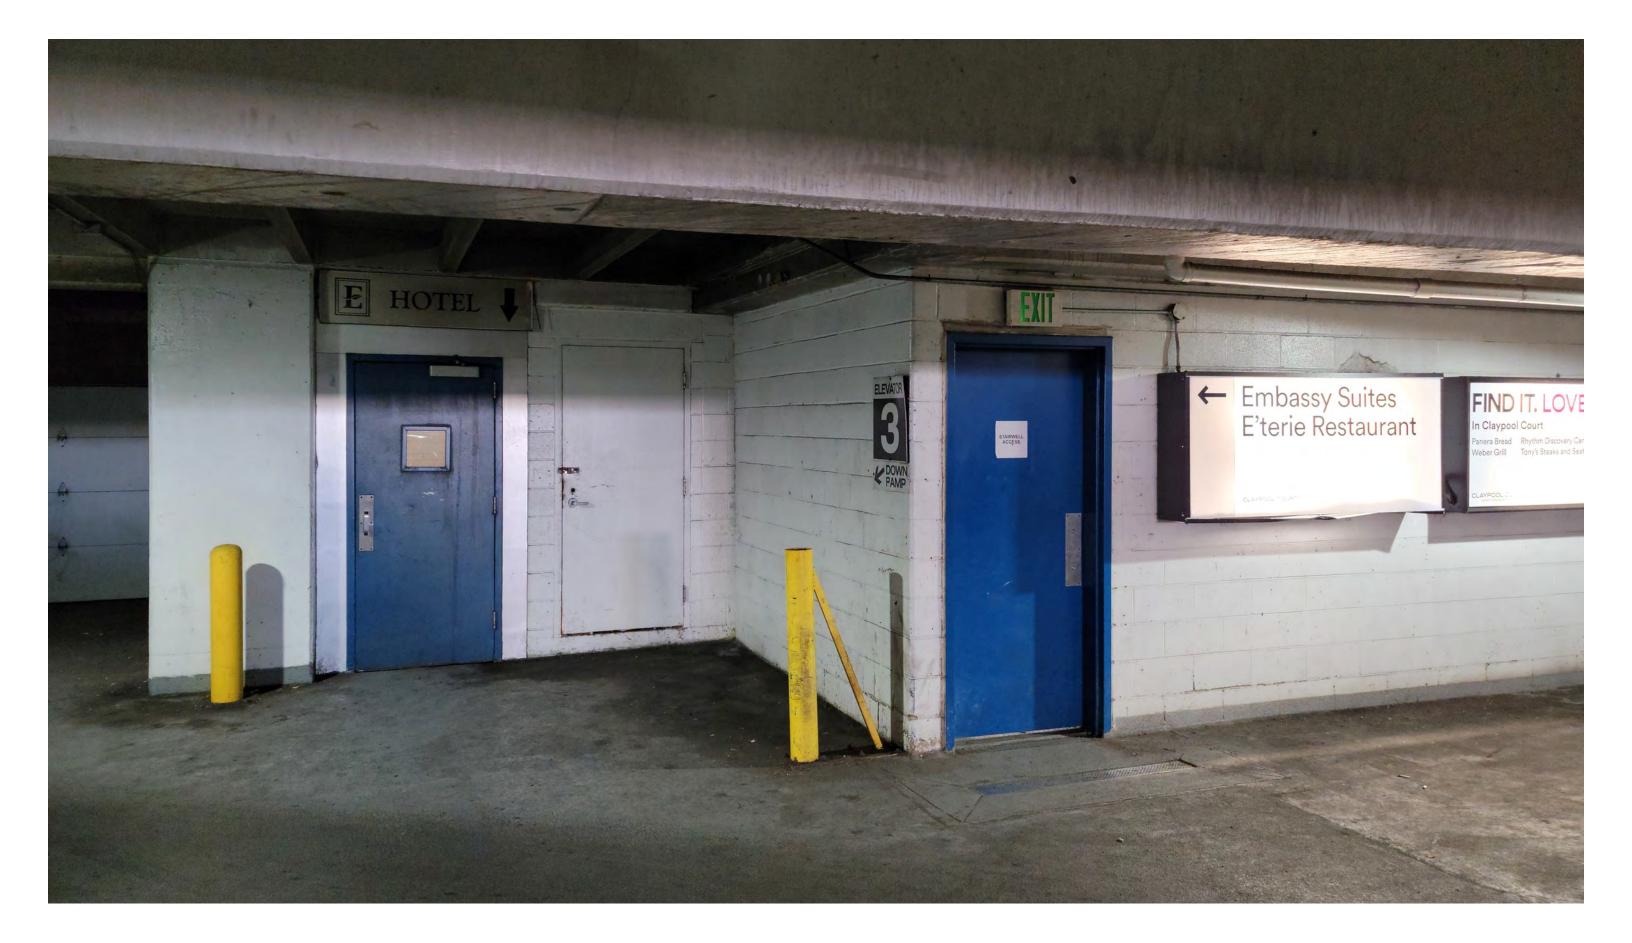












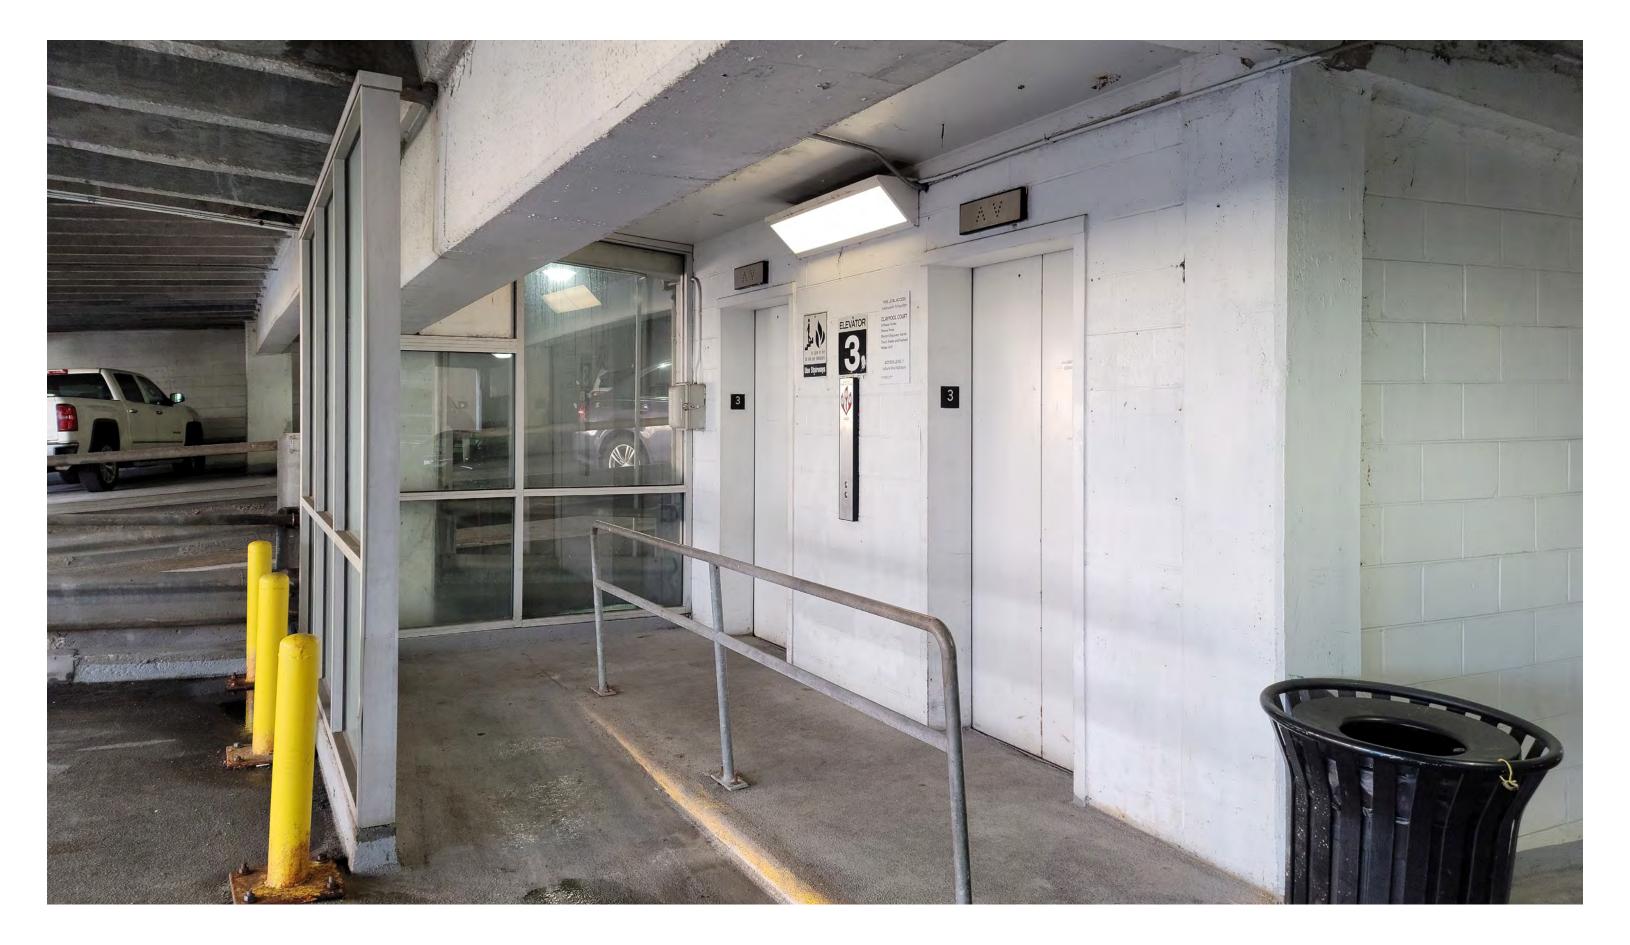












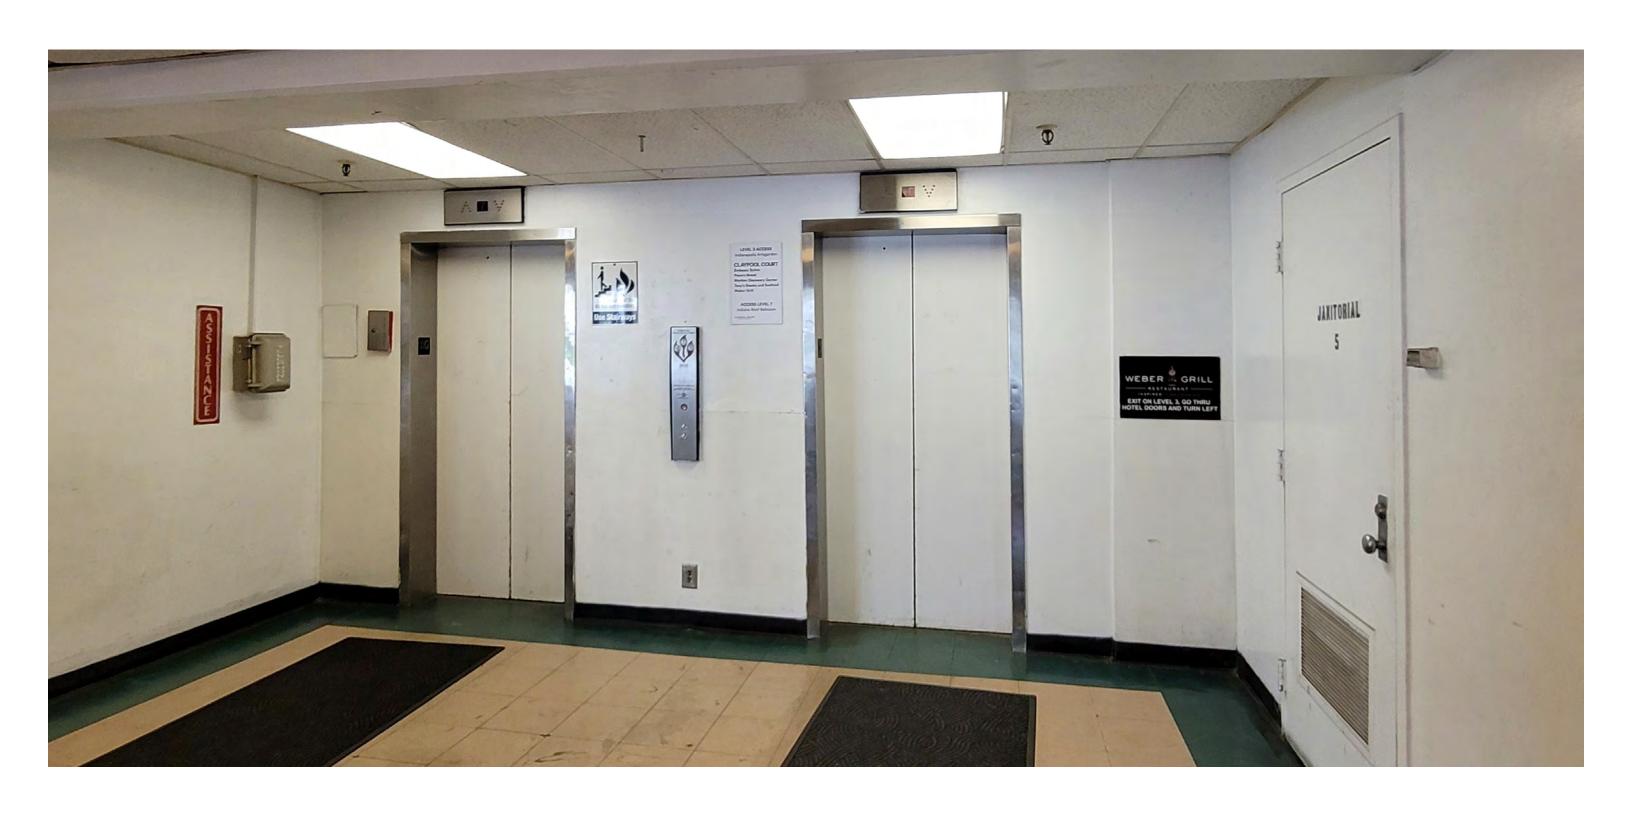


#### **GARAGE STREET ENTRANCE ELEVATOR LOBBY EXISTING**







#### **GARAGE STREET ENTRANCE ELEVATOR LOBBY RENOVATION**

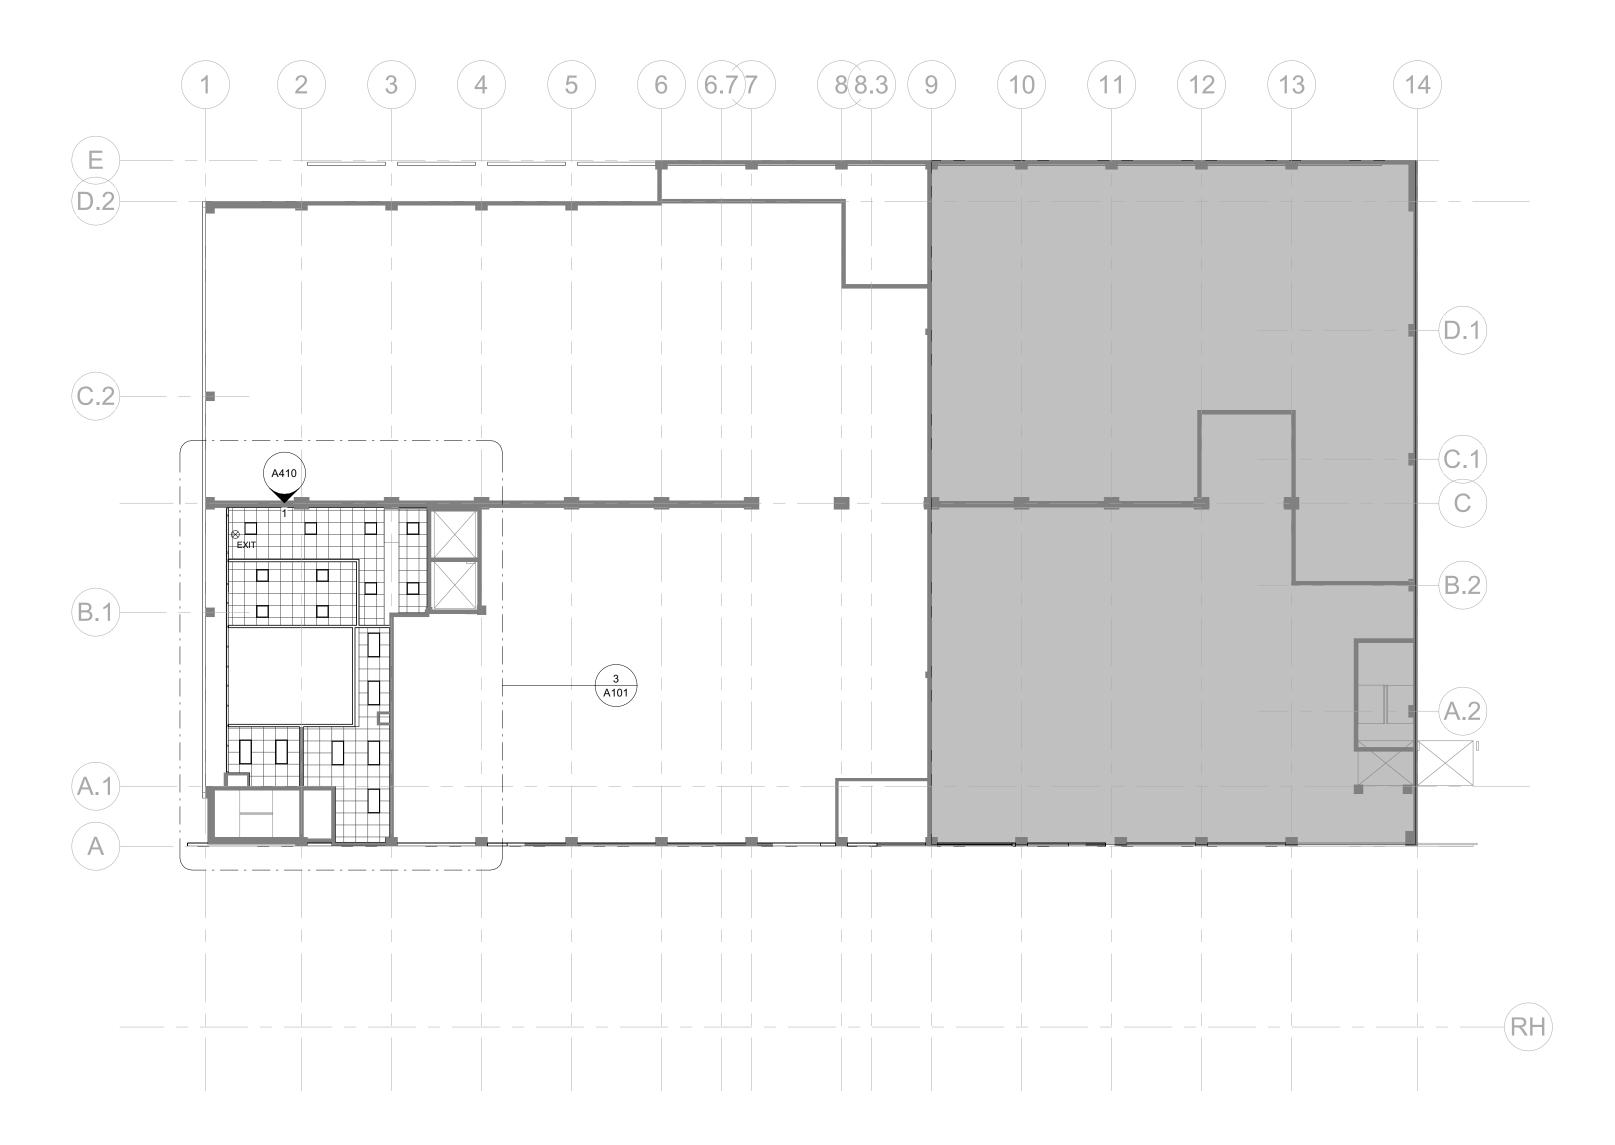


GROUND LEVEL CEILING PLAN

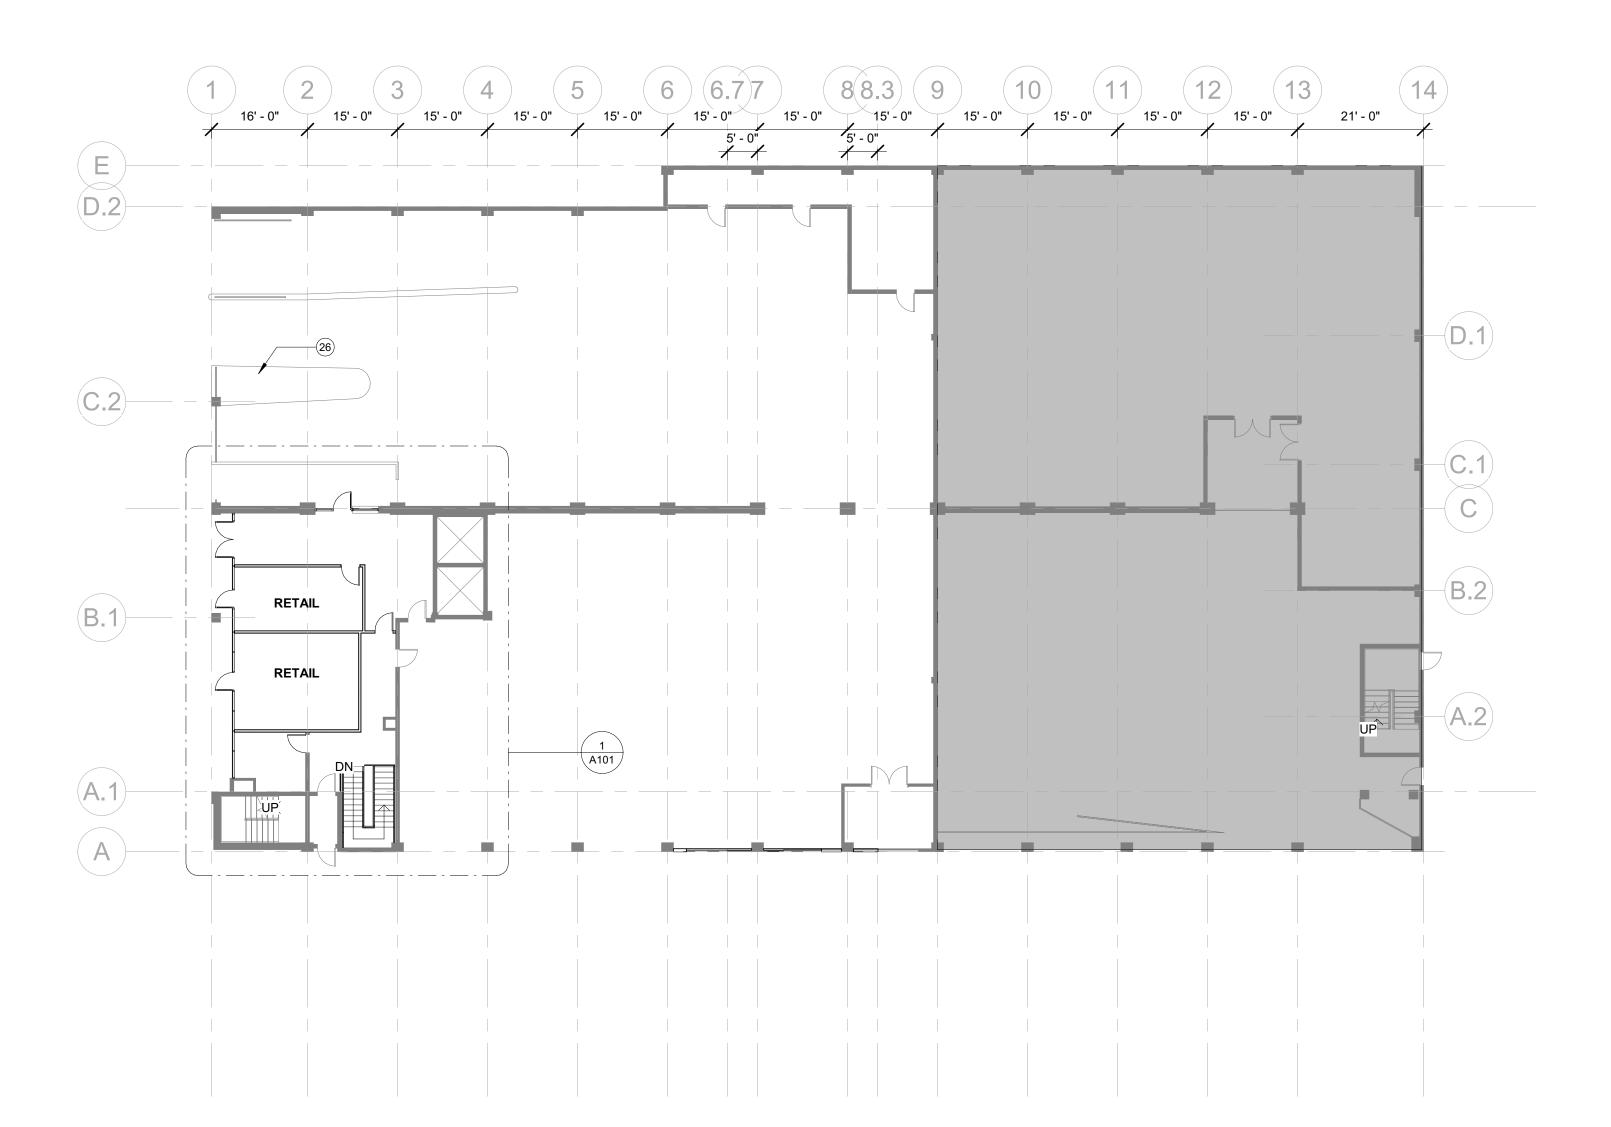

GROUND FLOOR PLAN

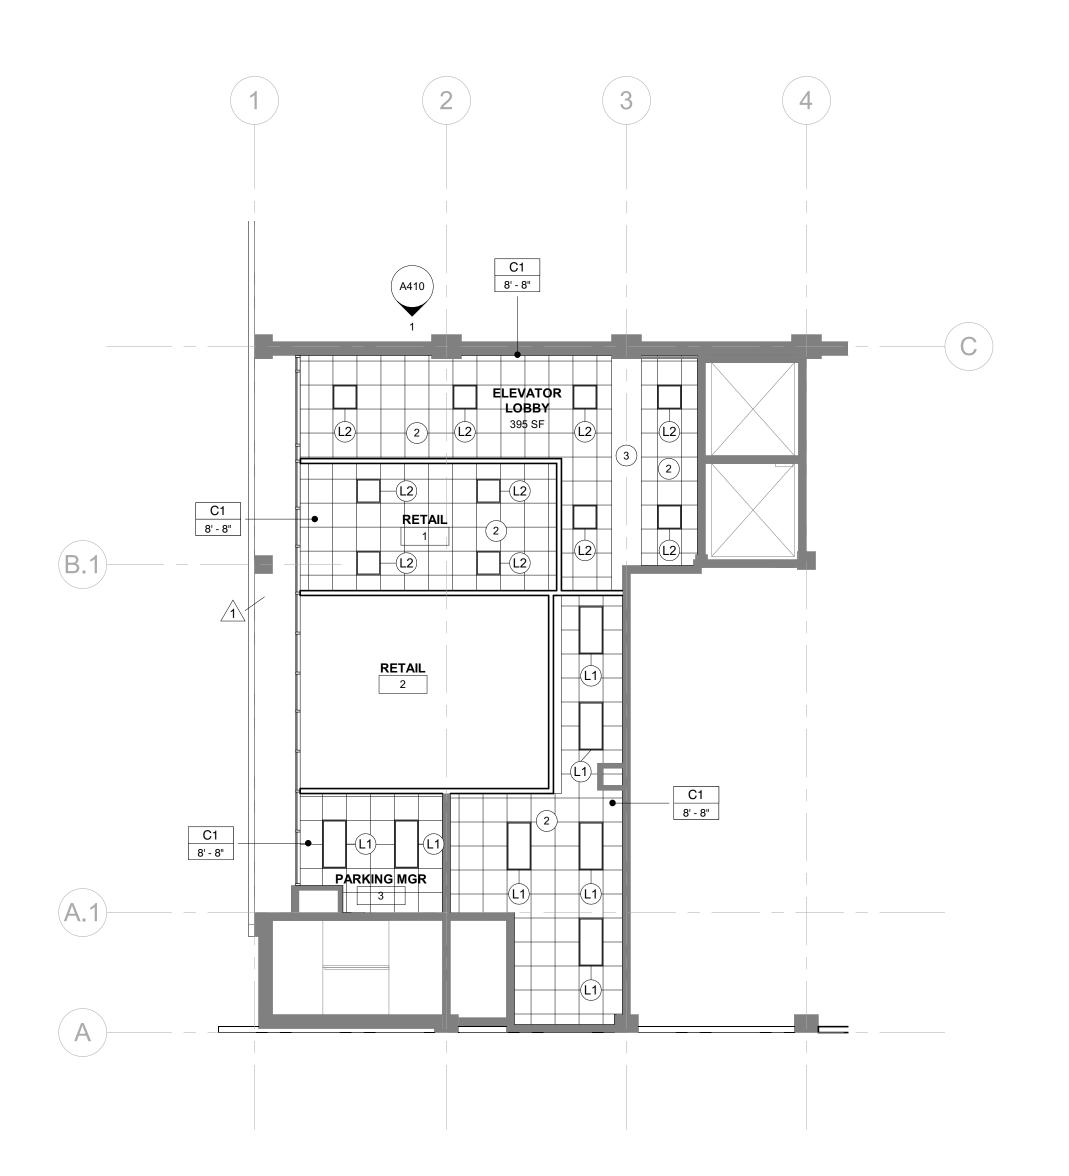

ENLARGED CEILING PLAN

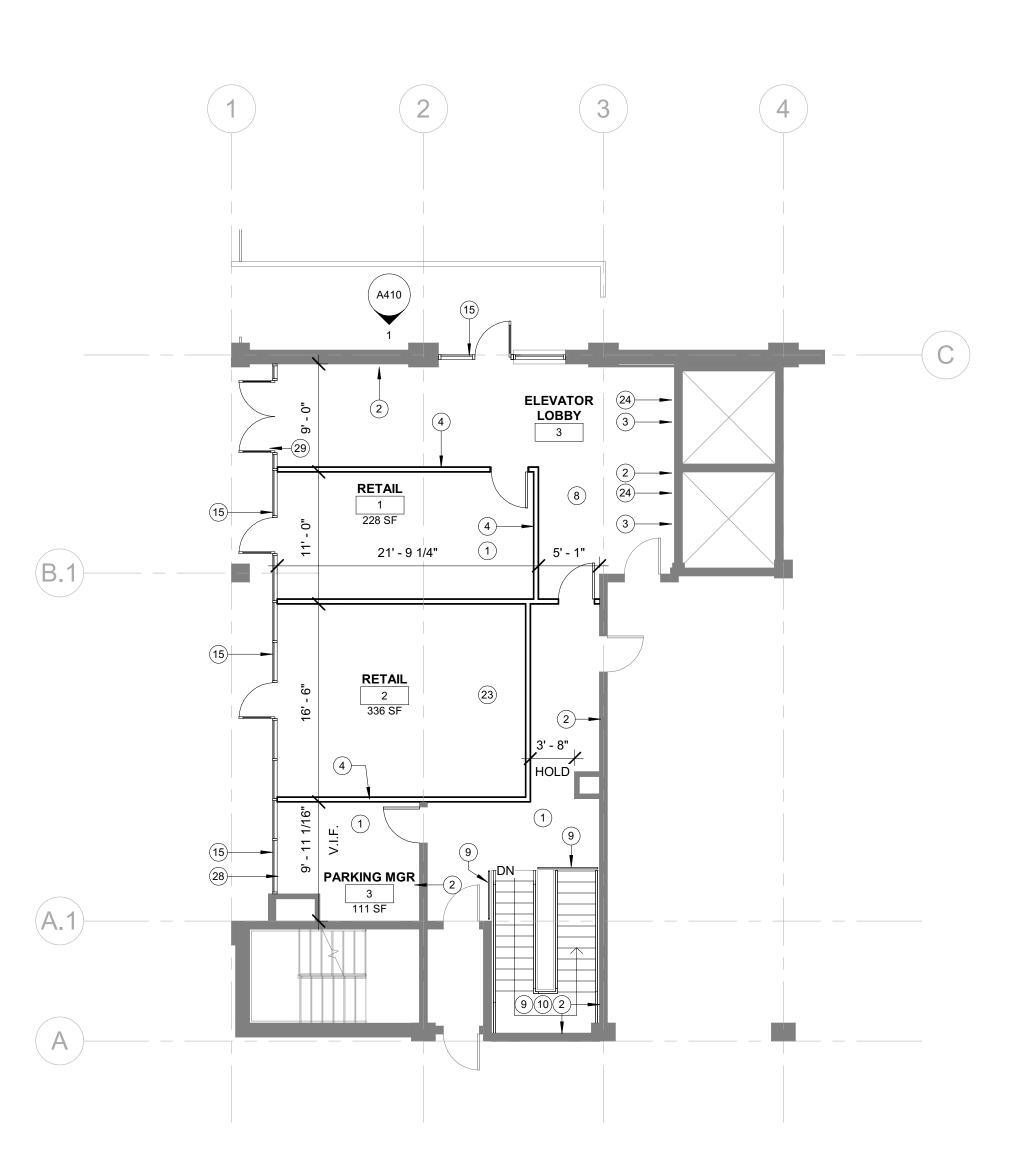

ENLARGED FLOOR PLAN

#### **GENERAL CEILING NOTES**

UKGr

**COURT STREET ASSOCIATES LLC** 

10 W MARKET ST

P: 317.614.0053 F: 317.632.3662

DKGRAR.COM

INDIANAPOLIS, IN 46204

350 MASSACHUSETTS AVENUE SUITE 400 INDIANAPOLIS, IN 46204

COURT

**STREET** 

04 MAY 2022

PROJECT #:

2021-023

SHEET REVISIONS

FLOOR PLANS -

LEVEL 01

**GARAGE** 

33 N CAPITOL AVE,

INDIANAPOLIS, IN 46204

- A. PROVIDE MOISTURE RESISTANT GYPSUM BOARD AT ALL WET LOCATIONS. INCLUDING BUT NOT LIMITED TO GARAGES AND BATHROOMS WITH SHOWERS.
- B. SEE INTERIOR ELEVATION AND OR SECTIONS FOR MOUNTING HEIGHTS OF ALL
- WALL MOUNTED FIXTURES
- C. REFER TO ELECTRICAL DRAWINGS FOR ALL LIGHT FIXTURE SPECIFICATIONS
- D. IN EXPOSED STRUCTURE CEILING AREAS, RUN ALL ELECTRICAL AND DATA CABLING IN HARD CONDUIT (NOT APPLICABLE IN DWELLING UNITS)
- E. PROVIDE OWNER WITH HVAC LAYOUT OF DIFFUSERS, BOXES, AND STAT LOCATIONS
- PRIOR TO INSTALLATION AS WELL AS A BALANCE REPORT AT CLOSE OF JOB. F. CENTER LIGHT FIXTURES IN ROOM UNLESS NOTED OTHERWISE.

G. REFERENCE ELECTRICAL SHEETS FOR LIGHTING SPECIFICATIONS AND ADDITIONAL

#### FIXTURE SCHEDULE

- 2 X 4 LOW PROFILE TROFFER LED FIXTURE LSI INDUSTRIES
- MODEL: OPT24-LED-FS2-48W-4000K
- METALUX CRUZE ST 22CZ2 MODEL:
- 36" ROUND SURFACE-MOUNTED LED FIXTURE, WET-RATED

2 X 2 LOW PROFILE TROFFER LED FIXTURE

- SIMILAR TO POP CORE 36 ROUND LED L4 TYPE: 89" SURFACE-MOUNTED LED FIXTURE, WET-RATED
- OCL MODEL: UNA, UA189MWMWP

\*NOTE: REFER TO ELECTRICAL PLANS FOR MORE INFORMATION. NOTIFY ARCHITECT OF ANY DISCREPANCIES. ALL LAMPS TO BE 3000-3500K COLOR TEMPERATURE.

#### **CEILING PLAN LEGEND**

1i 1'-0" **ELEVATION IDENTIFICATION** 

2'x4' SUSPENDED ACOUSTICAL CEILING

GYPSUM BOARD CEILING

EXPOSED STRUCTURE (WITH FIREPROOFING)

#### **CEILING PLAN NOTES**

- 2 INSTALL NEW 2X2 ACT CEILING SYSTEM WITH TEGULAR EDGE, C1. ARMSTRONG OPTIMA OR EQUAL IN 15/16" GRID.
- 3 PAINT EXPOSED CONCRETE BEAM.
- 4 OCL GLOWSTICK. 24" DEPTH. HOUSING TO BE BLACK
- 6 NEW CEMENTITIOUS GYPSUM BOARD CEILING SUSPENEDED FROM THE DECK ABOVE. 7 ALIGN TOP OF CEILING WITH TOP OF EXISTING EXTERIOR STOREFRONT MULLION.
- 8 PROVIDE SQUARE EDGE TRIM TO ALLOW EXISTING ELECTRICAL AND COMMUJICATION CONDUITS
- 9 EXISTING CONCRETE TO REMAIN

#### **GENERAL PLAN NOTES**

- ALL DIMENSIONS ARE TAKEN TO FACE OF METAL STUD, FACE OF CONCRETE, FACE OF MASONRY, FACE OF EXISTING FINISHES, OR FROM CENTER LINE OF EXISTING COLUMNS UNLESS NOTED AS CLEAR (CLR.) CLEAR DIMENSIONS INDICATE FINISH SURFACE TO FINISH SURFACE SPANS BETWEEN WALLS OR FROM FINISH SURFACE OF WALL TO LATCH/HINGE OF ADJACENT DOOR.
- B. CONTRACTOR SHALL VERIFY THE EXISTING CONDITIONS AND PROMPTLY NOTIFY THE OWNER AND THE ARCHITECT OF ANY CONDITIONS THAT ARE IN CONFLICT WITH THE PROPOSED WORK OR ARE IN VARIANCE WITH THE CONSTRUCTION
- C. CONTRACTOR SHALL PROTECT EXISTING MATERIALS, COMPONENTS, AND FEATURES DESIGNATED TO REMAIN, BE SALVAGED, AND/OR REUSED. (SEE DEMOLITION DRAWINGS.)
- D. CONTRACTOR SHALL COORDINATE WITH THE OWNER AND GOVERNING AUTHORITIES TO ESTABLISH CONSTRUCTION TRAFFIC ACCESS TO THE SITE AND DESIGNATED CONSTRUCTION ACCESS THROUGHOUT THE BUILDING.
- THESE DRAWINGS INDICATE THE GENERAL SCOPE OF THE PROJECT IN TERMS OF NOT INDICATE OR DESCRIBE THE WORK REQUIRED FOR THE FULL PERFORMANCE AND COMPLETION OF THE CONTRACT DOCUMENTS. ON THE BASIS OF THE GENERAL SCOPE INDICATED OR DESCRIBED THE CONTRACTOR SHALL STUDY THE DRAWINGS AND THEIR GENERAL INFERENCE TO FURNISH THE ITEMS REQUIRED FOR THE PROPER EXECUTION AND COMPLETION OF THE WORK.
- ALL DESIGN TEAM DRAWINGS SHALL BE USED TO LOCATE BUILDING ELEMENTS. CONTACT THE ARCHITECT WITH CONFLICTS, DESCREPANCIES, AND OMISSIONS PRIOR TO COMMENCEMENT OF WORK. WRITTEN DOCUMENTATION SHALL BE PROVIDED BY CONTRACTOR REGARDING SUCH ITEMS.
- G. ALL IN-WALL BLOCKING IS TO BE FIRE TREATED AS REQUIRED BY CODE.
- H. CONTRACTOR TO ENSURE ALL WALLS TO MEET FIRE SAFETY REQUIREMENTS

ALL EXISTING COLUMNS, INTERIOR AND EXTERIOR WALLS, AND WINDOW WALLS TO BE DRYWALLED, TAPED, PAINTED, AND READY FOR NEW FINISH.

#### **PLAN NOTES**

- INSTALL NEW LVT1 TILE, ARMSTRONG TERRA ATRO RAVENNA ST892 ATRO WITH 4" RESILIENT BASE AROUND PERIMETER
- REPAIR EXISTING WALL AS NEEDED TO RECEIVE NEW PAINT FINISH, GRAPHICS AND WAYFINDING INFORMATION. COLOR TO BE SELECTED BY ARCHITECT FROM MANUFACTURER'S
- REPLACE EXISTING ELEVATOR DOOR FRAMES WITH NEW. FINISH TO MATCH EXISTING. 4 NEW INTERIOR WALLS TO BE TYPE A3-S WITH SOUND ATTENUATING BATT INSULATION AND LEVEL 04 FINISH U.N.O. PAINT TBD.
- 5 REPLACE EXISITNG BOLLARD WITH NEW 3'-6" TALL CONCRETE BOLLARD WITH STAINLESS STEEL
- 6 CLEAN AND REFINISH CONCRETE. PAINT P4. TRAFFIC COATING.
- 7 CUSTOM VINYL GRAPHIC APPLIED TO EXISTING PAINTED WALL 8 INSTALL NEW CERAMIC TILE FLOORING, CT1, MILESTONE EPIC DOLOMITE 12"X24", MATTE, WITH
- 4" VINYL COVE BASE AROUND PERIMETER.
- 9 NEW ANODIZED ALUMINUM GUARDRAIL AND HANDRAILS AT EXISTING STAIR 10 NEW LVT 1 STAIR TREADS AND LANDINGS


11 PAINT EXISTING HOLLOW METAL DOOR AND FRAME TO MATCH WALL COLOR.

- 12 NEW ENTRYWAY CARPET TILE, SHAW CONTRACT JIVE STEP 12549 OR EQUAL, ASHLAR PATTERN 13 PAINT EXISTING METAL HANDRAIL AND SADDLE BRACKETS.
- 14 REPLACE EXISTING STAINLESS STEEL ELEVATOR DOOR FRAMES. REPLACE EXISTING ELEVATOR
- CALL BUTTON AND CALL SIGNALS. 15 NEW ANODIZED ALUMINUM STOREFRONT SYSTEM, SIMILAR TO EFCO 451T
- 16 APPLY VINYL CUSTOM GRAPHIC TO STOREFRONT GLAZING
- 17 NEW ALUMINUM TWO RAIL SYSTEM. TOP TO BE AT 42" A.F.F.
- 18 PAINT EXISTING ELEVATOR DOORS AND FRAMES TO BE PAINTED TO MATCH WALL COLOR 20 REMOVE EXISTING GLASS STRUCTURE AND REPLACE WITH NEW STOREFRONT STRUCTURE.
- 21 NEW HOLLOW METAL DOOR AND FRAME TO MATCH WALL COLOR. 23 PREPARE EXISTING CONCRETE FINISH TO RECEIVE NEW TENANT FINISHES
- 24 ALUMINUM TILE REDUCER STRIP, SIMILAR TO SCHLUTER RENO-RAMP, TO TRANSITION FROM NEW TILE HEIGHT TO EXISTING ELEVATOR SILL.
- 25 STRIPED LANE WITH "NO PARK" DIAGONAL LINES AND IMPACT RESISTANT FLEXIBLE DELINEATORS ON ENTRY LANE
- 26 NEW RAISED EQUIPMENT ISLAND WITH ACCESS CONTROL/TICKETING ARMS. COORDINATE
- POWER AND DATA REQUIREMENTS WITH PARKING GARAGE OPERATOR. 27 REPLACE EXISTING DOOR WITH NEW ALUMINUM STOREFRONT FRAME AND DOOR, FULL LITE,
- TO MATCH NEW STOREFRONT SYSTEM. 28 PRIVACY FILM ON INTERIOR GLASS LITE AT PARKING MGR 3 ONLY, SIMILAR TO 3M FASARA
- 29 DOORT

No. 10500156

STATE OF

02-16-2022

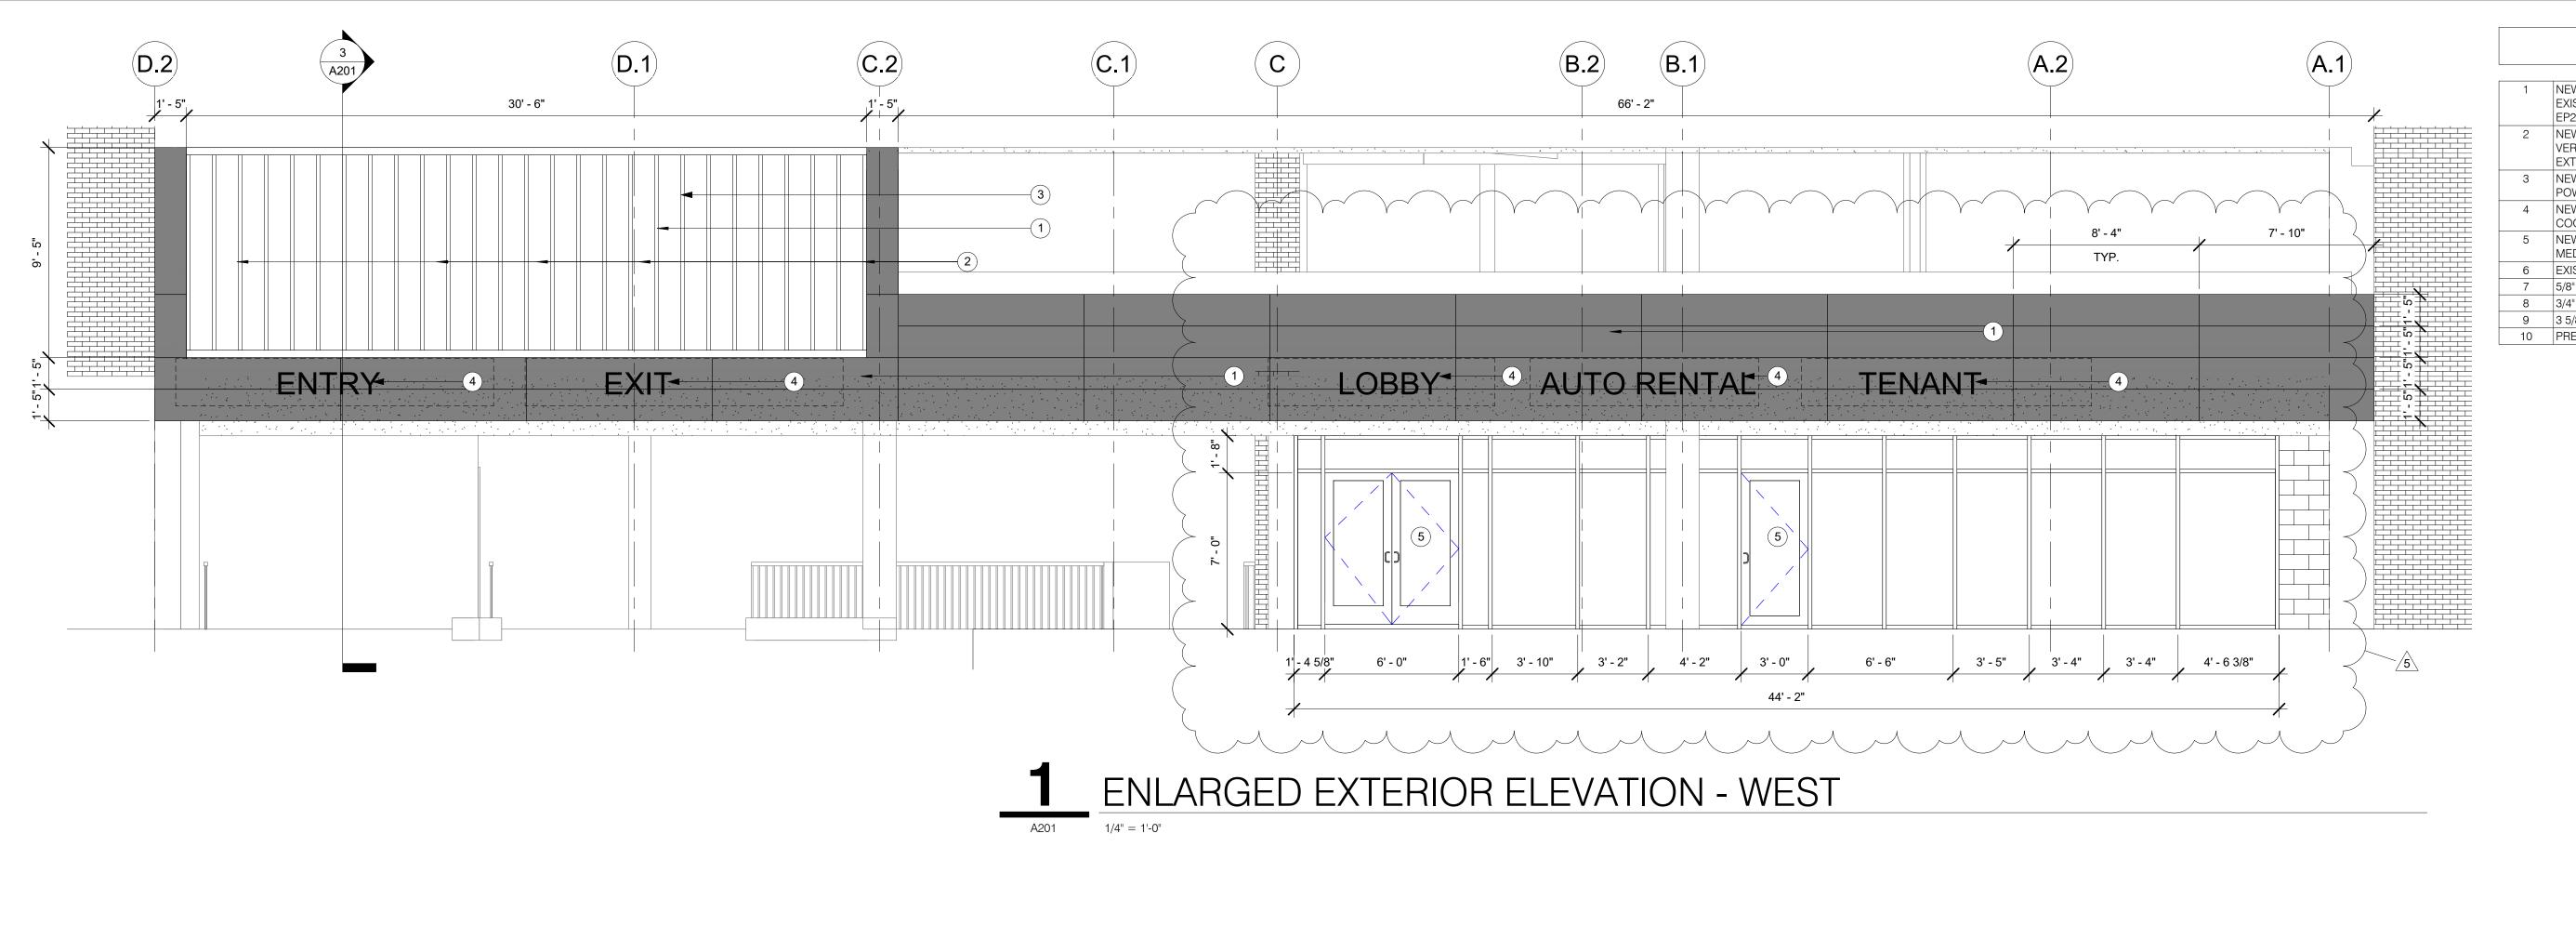

WHITE PANELS BEHIND FIN SYSTEM

BLACK PANELS OUTSIDE OF FIN SYSTEM

#### **EXTERIOR ELEVATION NOTES**

- NEW EXTERIOR SOLID PHENOLIC CLADDING PANEL WITH CONCEALED FIXING SYSTEM ON RAILS ATTACHED TO EXISTING CONCRETE AND MASONRY EXTERIOR MATERIAL. NEW PANELS ARE TO BE TRESPA METEON SPECULAR,
- 2 NEW EXTERIOR EXTRUDED ALUMINUM VERTICAL FINS WITH TOP AND BOTTOM EXTRUDED ALUMINUM RAILS. VERTICAL RAILS TO BE 2" WIDE AND 8" DEEP. HORIZONTAL FINS TO BE 4" TALL BY 8" DEEP. ALL ALUMINUM EXTRISIONS TO BE POWDER COATED SIMILAR TO AMERICAN PRODUCTS INC. EXTERIOR FIN SYSTEM.
- 3 NEW INTEGRAL PROGRAMMABLE LED COVE LIGHTING SYSTEM WITHIN FIN SYSTEM. COORDINATE BLOCKING AND
- 4 NEW SIGNAGE PINNED TO NEW EXTERIOR CLADDING SYSTEM. PROVIDE POWER AND BACKING AS REQUIRED, COORDINATE REQUIREMENTS WITH SIGNAGE VENDOR.
- NEW THERMALLY BROKEN CLEAR ANODIZED STOREFRONT SYSTEM WITH 1" THERMALLY INSULATED GLAZING AND
- 6 EXISTING CONCRETE SPANDRELS TO REMAIN, TYP.
- 7 5/8" EXTERIOR GYPSUM BOARD, PAINTED BLACK, SHERWIN WILLIAMS SW6258 TRICORN BLACK
- 9 3 5/8" 18 GAUGE METAL STUD FRAMING AT 16" O.C. WITH HORZONTAL BRACING EVERY 48" O.C. 10 PRE-FINISHED METAL COPING

(B.2)(B.1)


8 3/4" EXTERIOR GRADE PLYWOOD SHEATHING WITH WEATHER BARRIER.

### UKGr

10 W MARKET ST SUITE 800 INDIANAPOLIS, IN 46204 P: 317.614.0053 F: 317.632.3662 DKGRAR.COM

COURT STREET ASSOCIATES LLC

350 MASSACHUSETTS AVENUE SUITE 400 INDIANAPOLIS, IN 46204

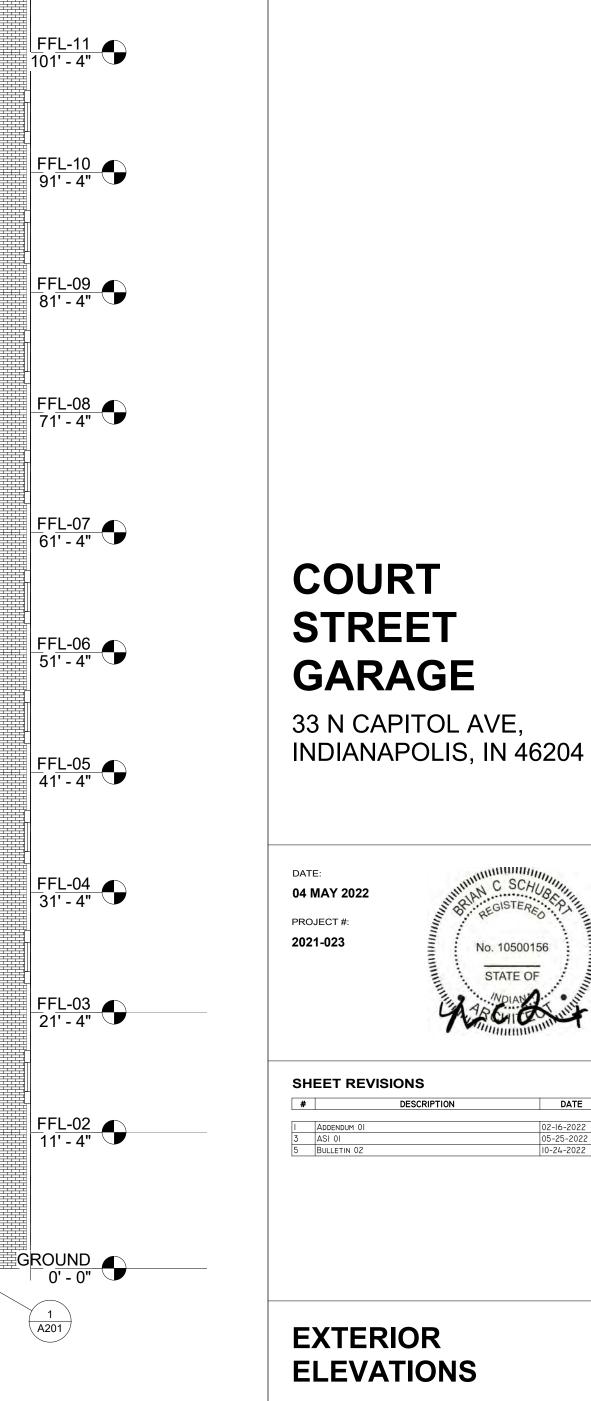


FFL-12 111' - 4"

No. 10500156

FIN SYSTEM SECTION

2 EXTERIOR ELEVATION - WEST

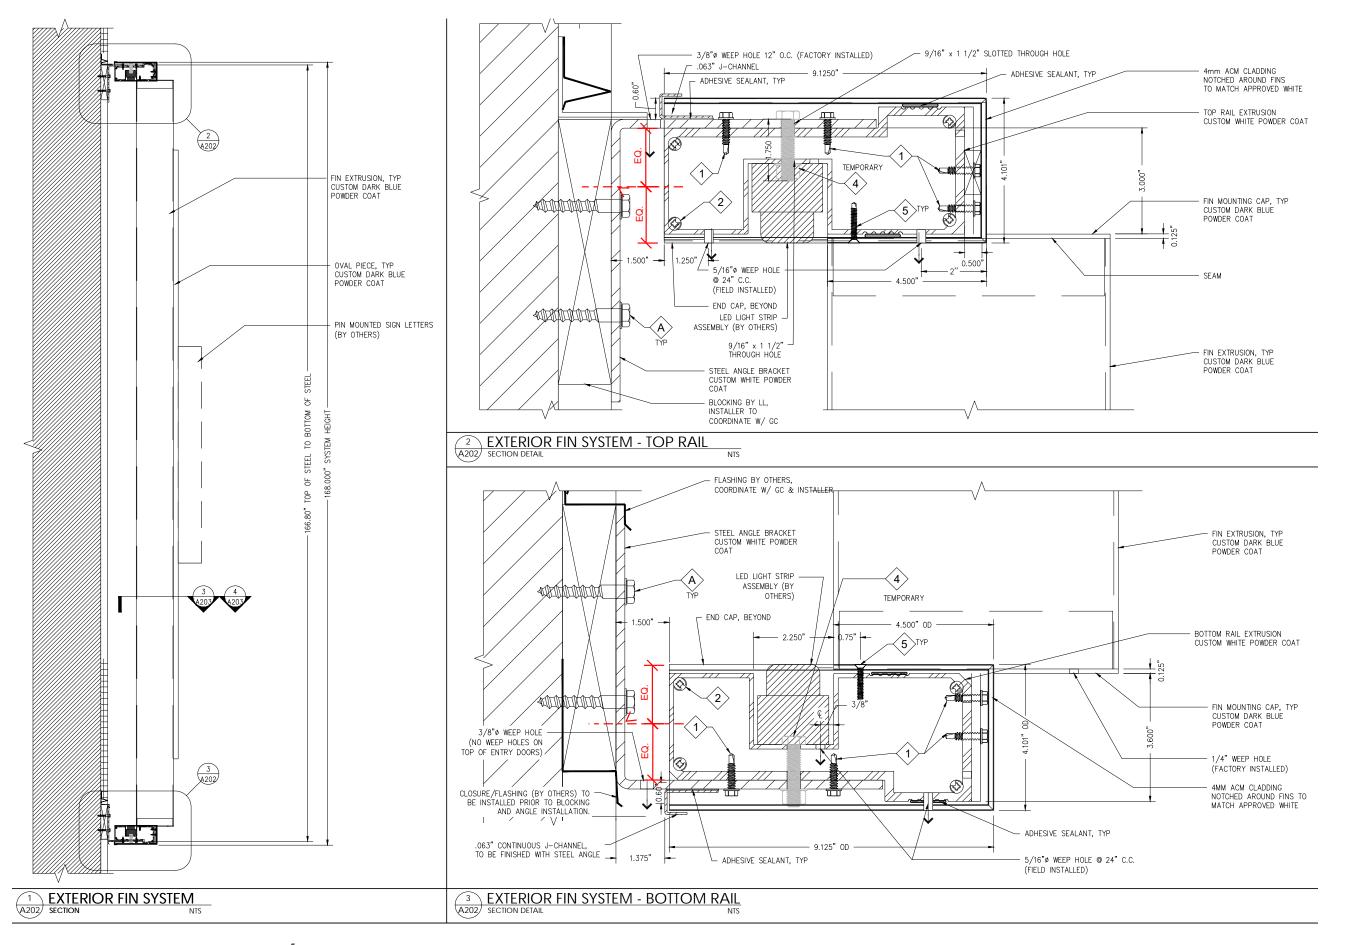








The area surround the vertical fin system will be black metal panel, similar to adjacent Tony's restaurant exterior. Vertical aluminum extrusion fins at Embassy Suites and Court Street garage exterior will be white, with white metal panel beyond. Horizontal aluminum channels at the top and bottom of the vertical fins will host linear RGBW lighting strips, (similar to backlit panels at adjacent Tony's restaurant) that will slowly gradate between various colors. Maximum speed between alternating colors will be 5 seconds. There will no flashing or other lighting effects.



**UKG**r

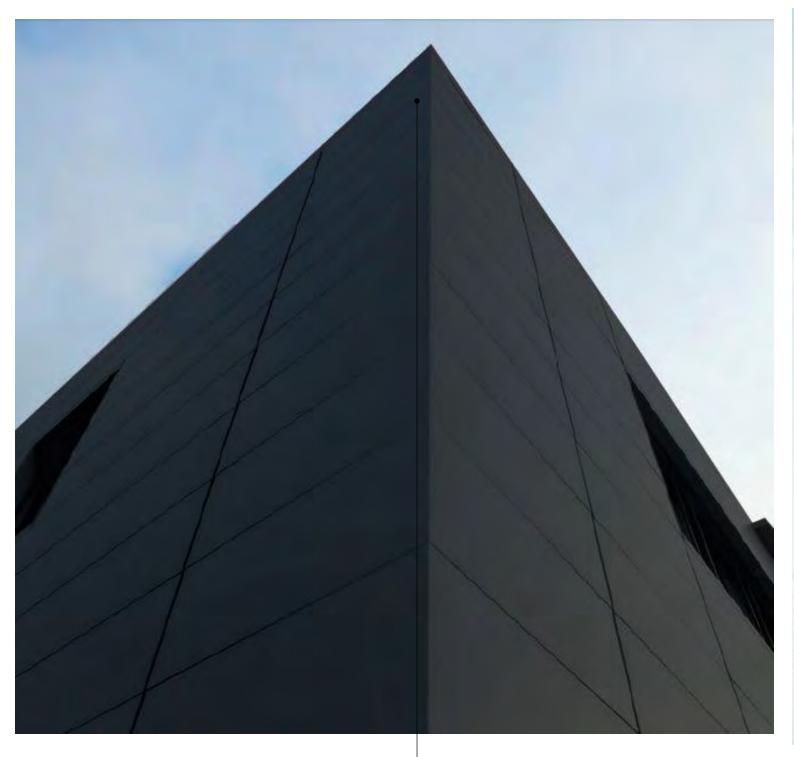



The area surround the vertical fin system will be black metal panel, similar to adjacent Tony's restaurant exterior.

Facade behind the vertical aluminum white fins will be white metal panel, to be surface lit from above and below with continuous RGBW LED lighting.



**UKG**r

# 2022-COA-436 (MCD) 110 WEST WASHINGTON STREET




# EMBASSY SUITES EXTERIOR RENOVATION

IHPC REVIEW PACKAGE
JULY 2022

#### DKGR

10 W MARKET ST SUITE 800 INDIANAPOLIS, IN 46204 P: 317.614.0053 F: 317.632.3662 DKGR@DKGRAR.COM

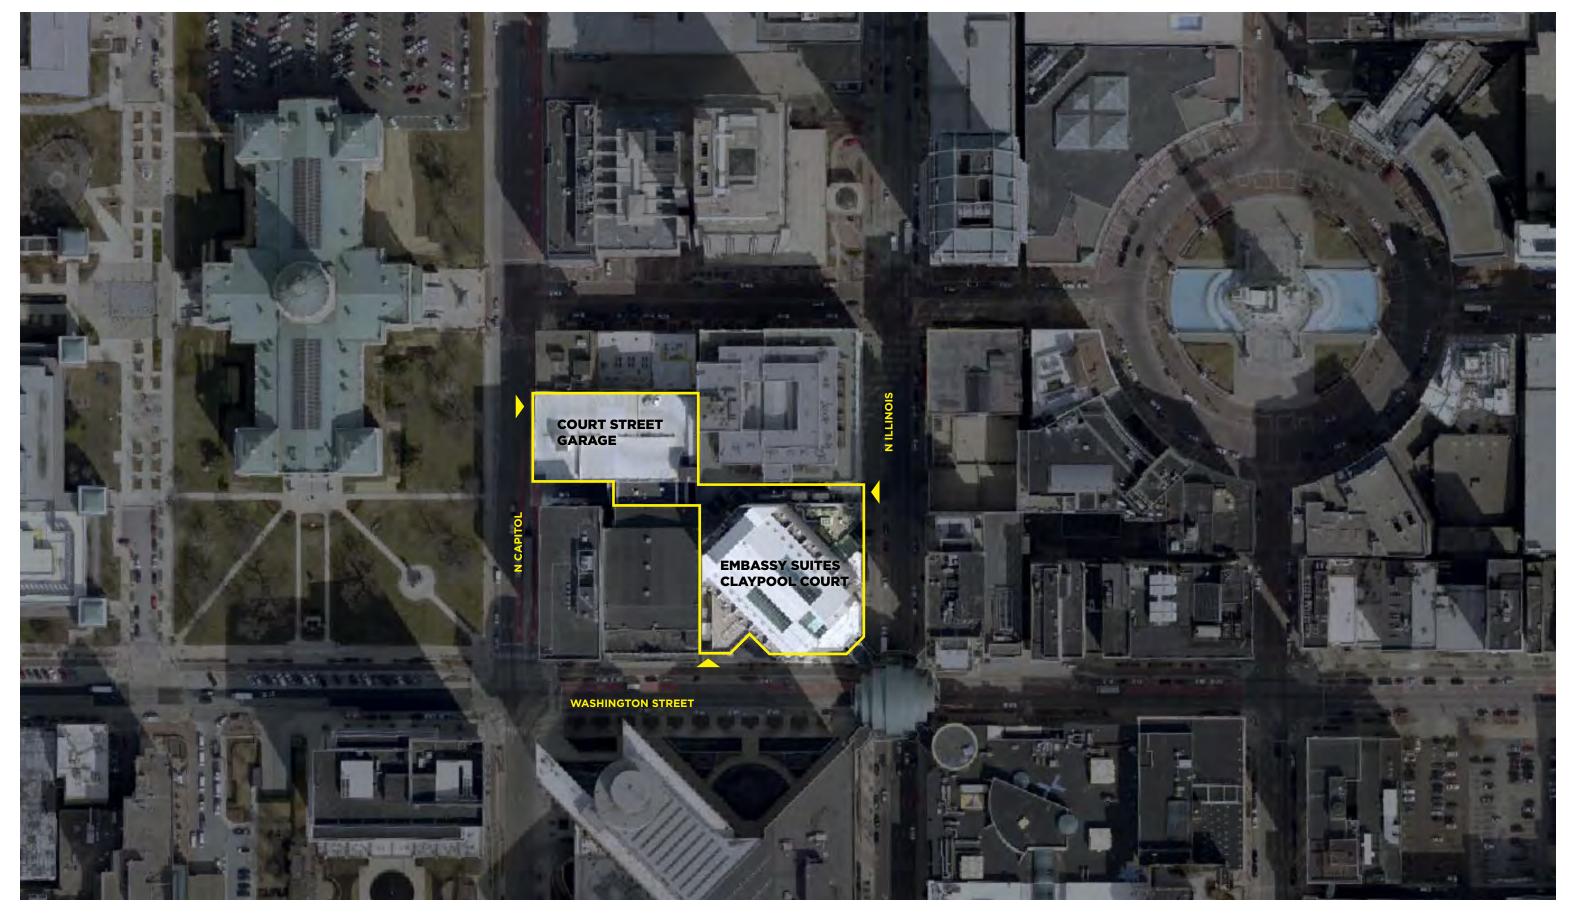







The current entrance is not well-marked, with limited branding. We have proposed a new metal panel overlay at the lower portion of exterior concrete panels that would align with the adjacent restaurant facade and create some visual continuity between the two.





#### **EXISTING WASHINGTON STREET ENTRANCE**

**EMBASSY SUITES EXTERIOR RENOVATION** JULY 2022







## **RENOVATED WASHINGTON STREET ENTRANCE**



## **EMBASSY SUITES PEDESTRIAN ENTRANCE EXISTING**













#### **EMBASSY SUITES PEDESTRIAN ENTRANCE RENOVATION**

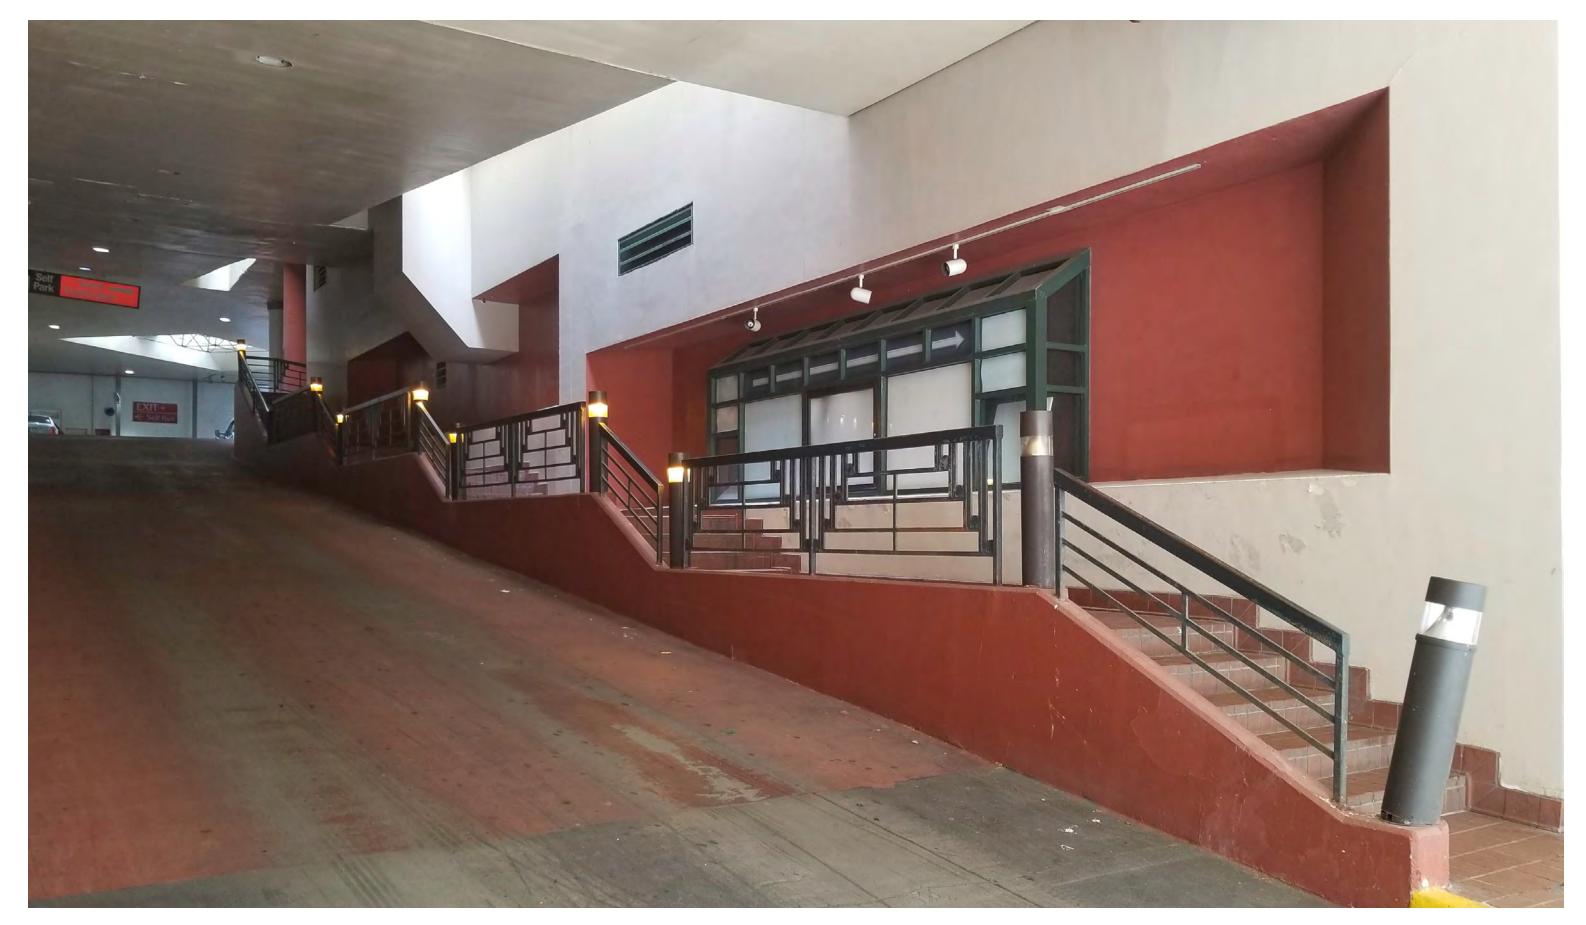









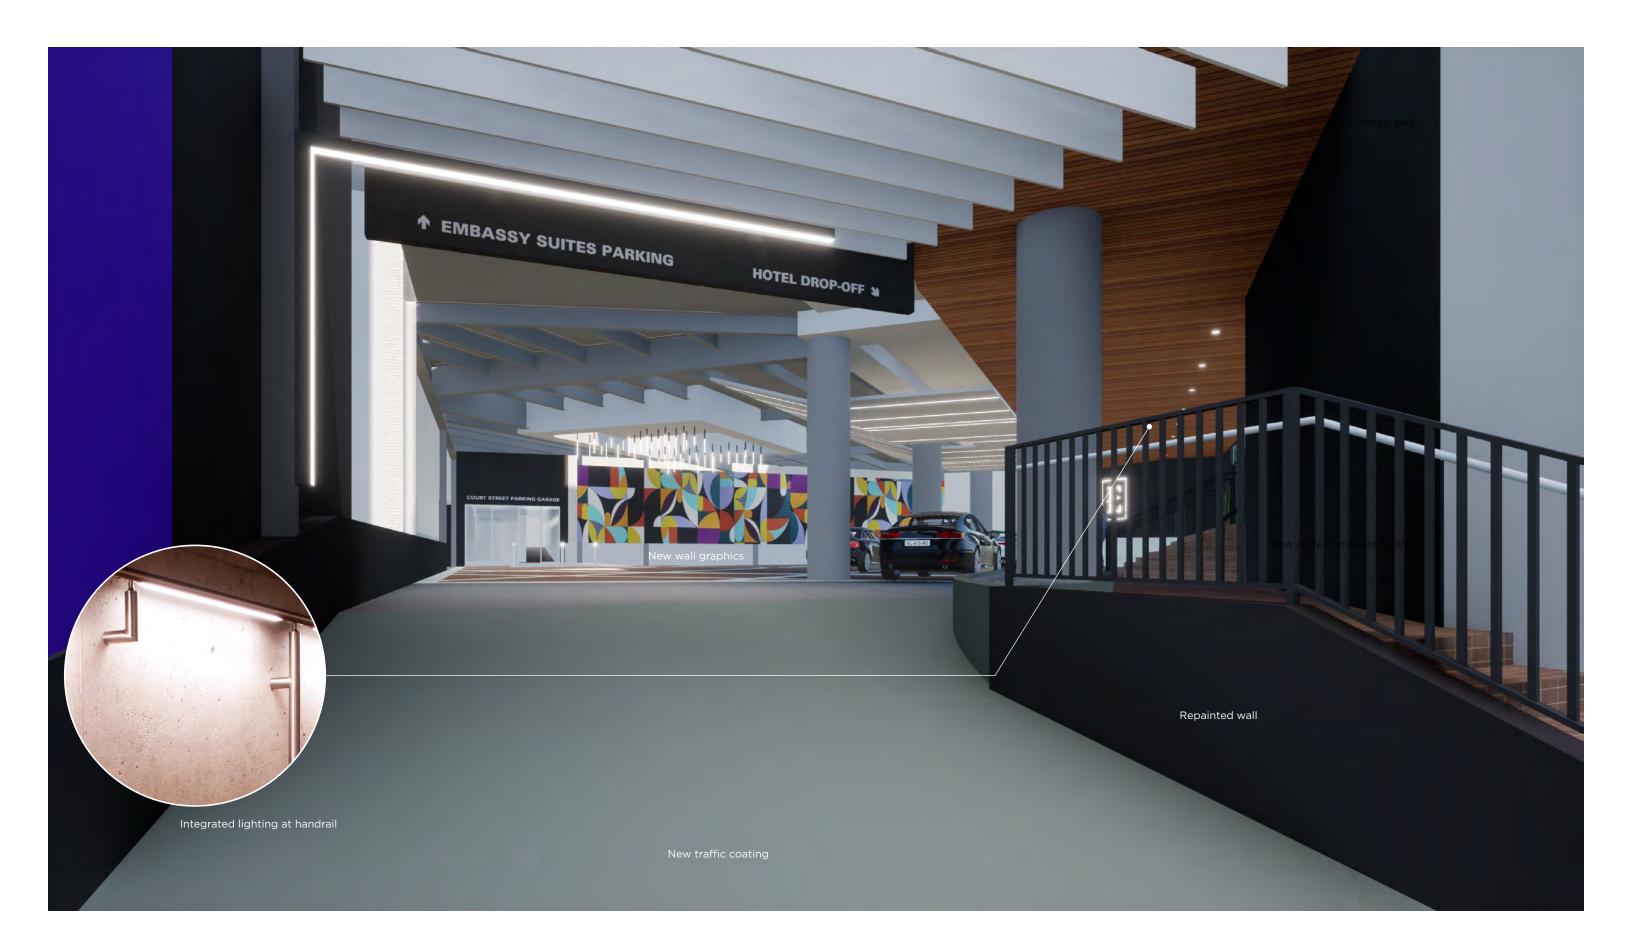


#### **RENOVATED PEDESTRIAN WALKWAY**

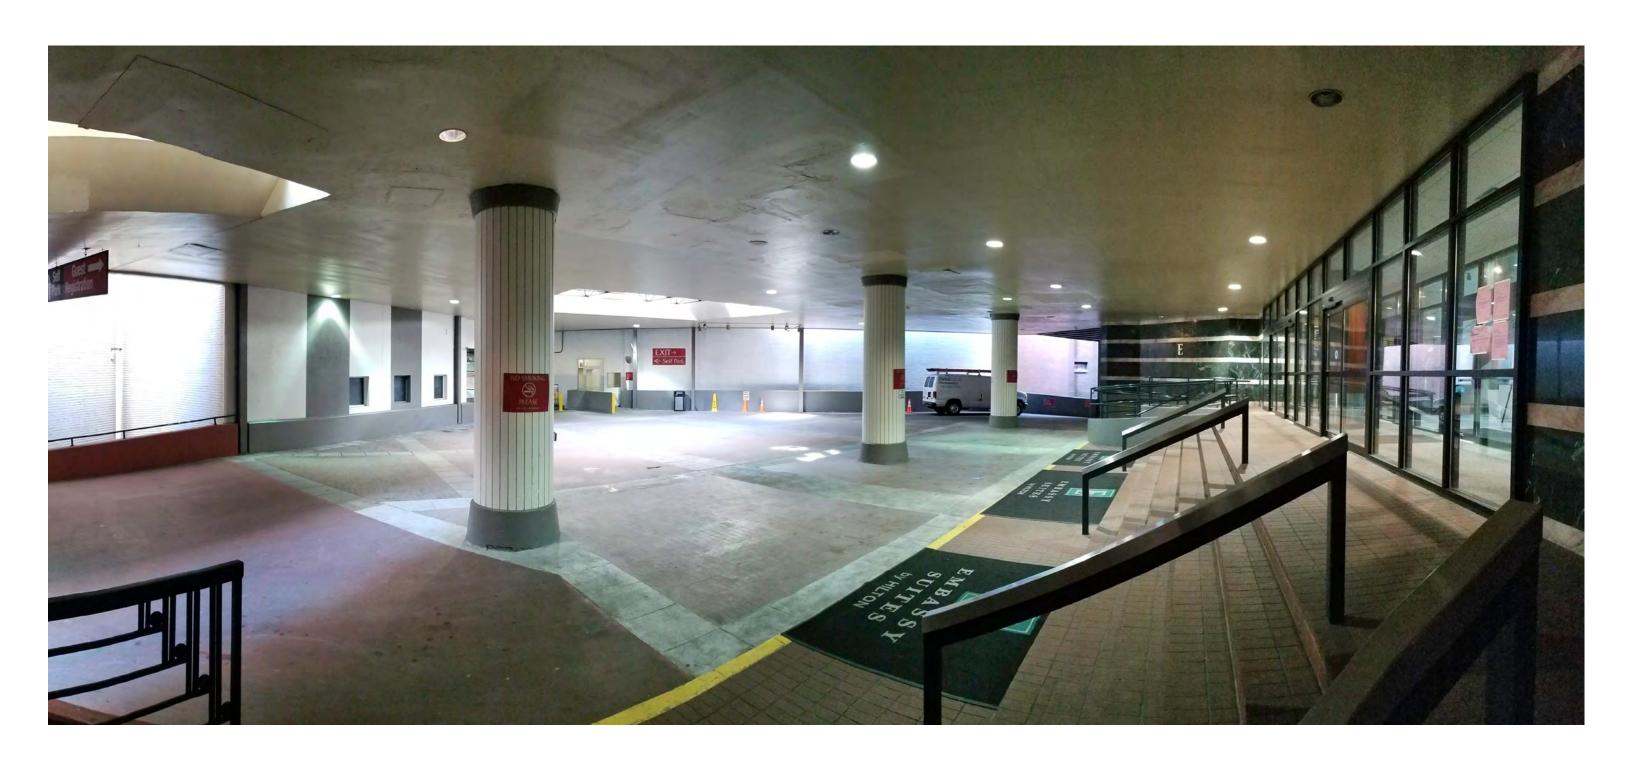


## **EXISTING MOTORCOURT**

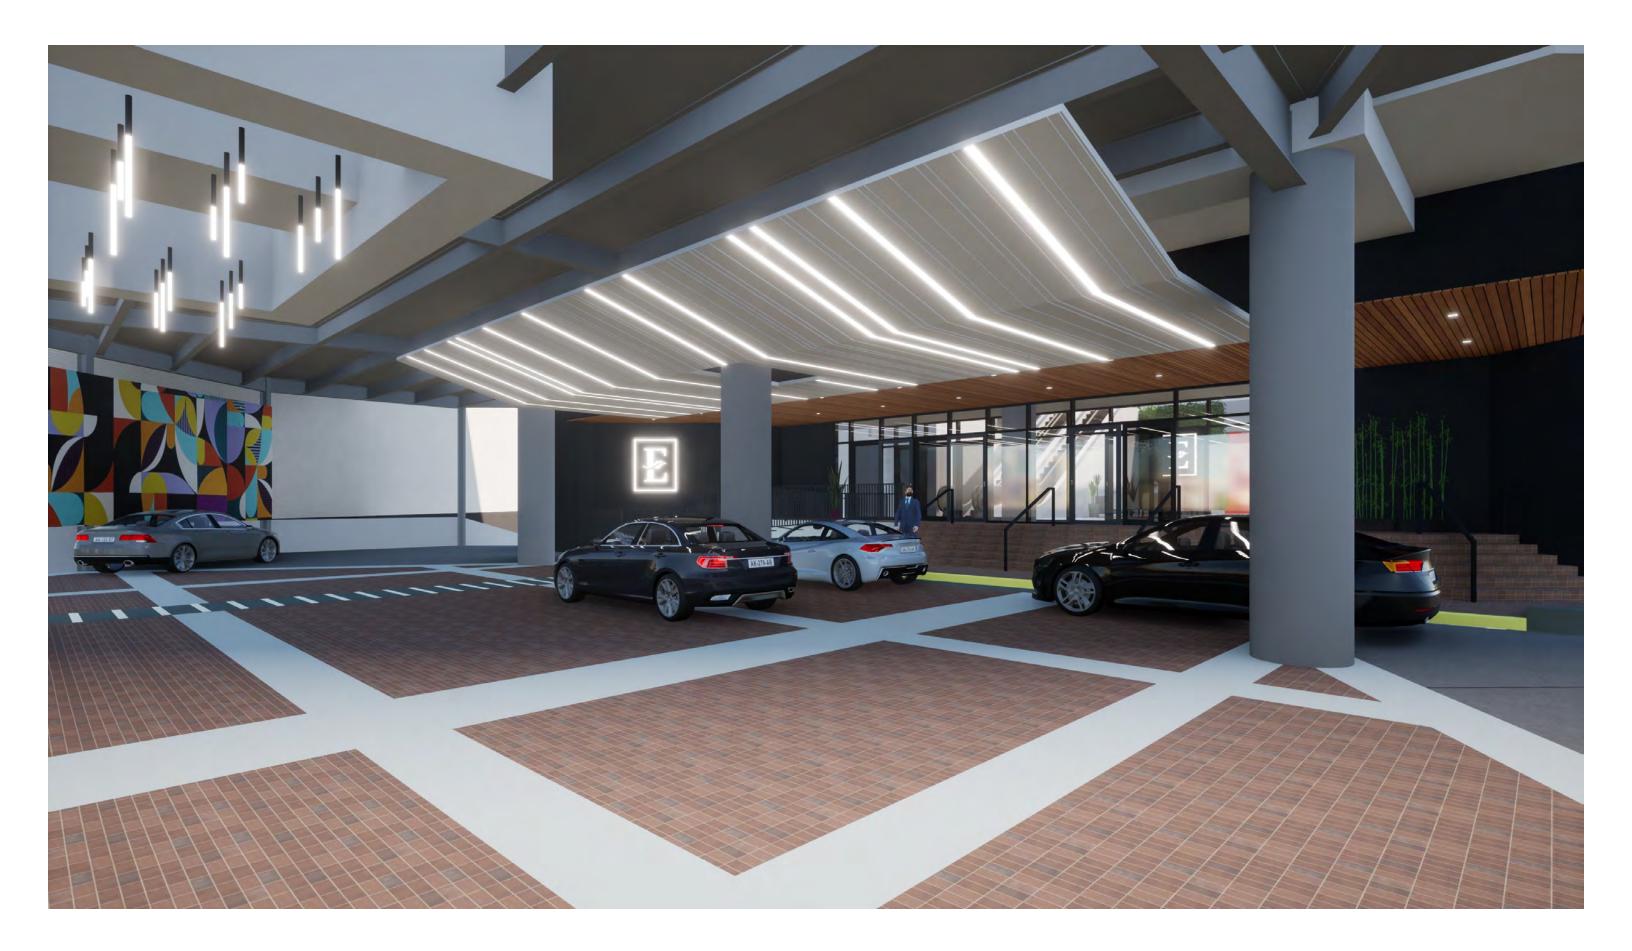



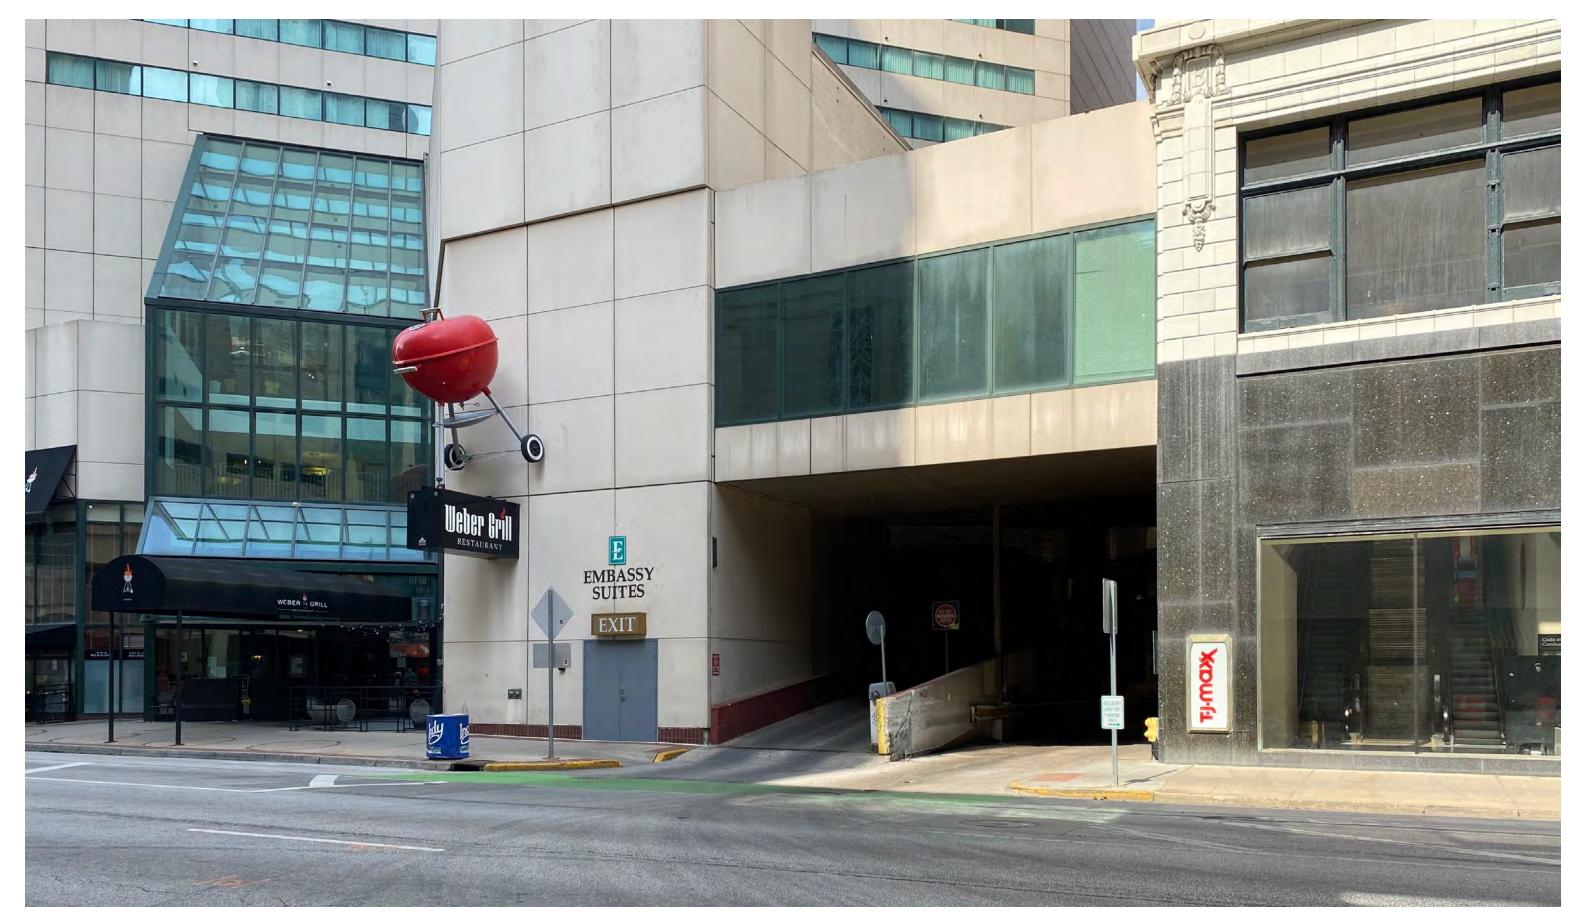



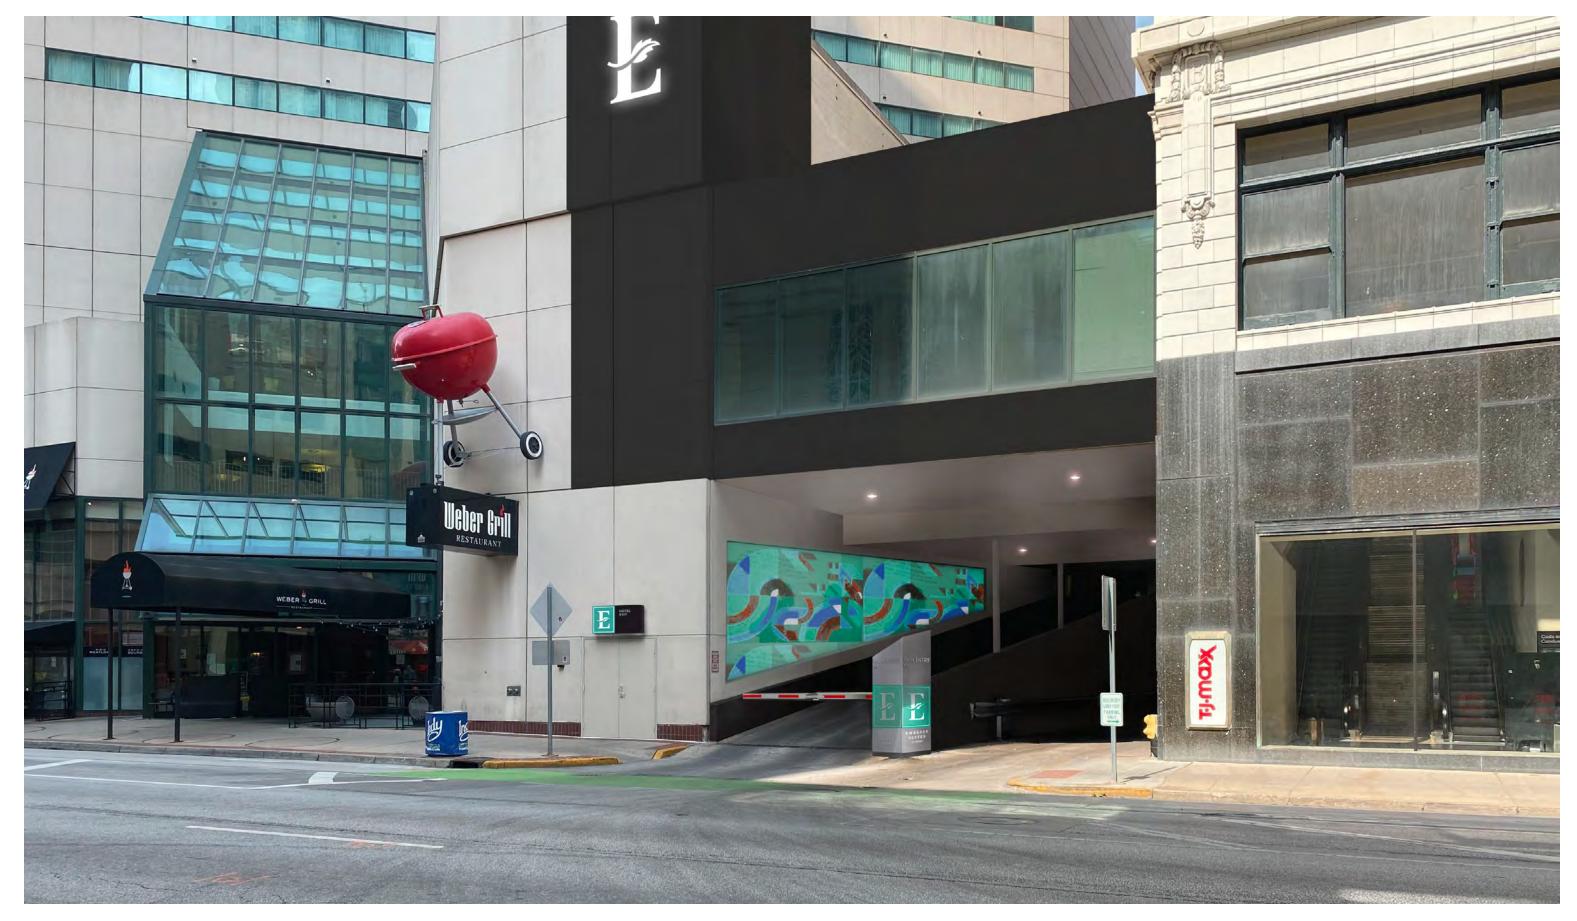



## **GENERAL PLAN NOTES**

- A. ALL DIMENSIONS ARE TAKEN TO FACE OF METAL STUD, FACE OF CONCRETE, FACE OF MASONRY, FACE OF EXISTING FINISHES, OR FROM CENTER LINE OF EXISTING COLUMNS UNLESS NOTED AS CLEAR (CLR.) CLEAR DIMENSIONS INDICATE FINISH SURFACE TO FINISH SURFACE SPANS BETWEEN WALLS OR FROM FINISH SURFACE OF WALL TO LATCH/HINGE OF ADJACENT DOOR.
  - B. CONTRACTOR SHALL VERIFY THE EXISTING CONDITIONS AND PROMPTLY NOTIFY THE OWNER AND THE ARCHITECT OF ANY CONDITIONS THAT ARE IN CONFLICT WITH THE PROPOSED WORK OR ARE IN VARIANCE WITH THE CONSTRUCTION DOCUMENTS.
  - C. CONTRACTOR SHALL PROTECT EXISTING MATERIALS, COMPONENTS, AND FEATURES DESIGNATED TO REMAIN, BE SALVAGED, AND/OR REUSED. (SEE DEMOLITION DRAWINGS.)
  - D. CONTRACTOR SHALL COORDINATE WITH THE OWNER AND GOVERNING AUTHORITIES TO ESTABLISH CONSTRUCTION TRAFFIC ACCESS TO THE SITE AND DESIGNATED CONSTRUCTION ACCESS THROUGHOUT THE BUILDING.
  - E. THESE DRAWINGS INDICATE THE GENERAL SCOPE OF THE PROJECT IN TERMS OF ARCHITECTURAL DESIGN CONCEPT, THE DIMENSIONS OF THE BUILDING, AND THE MAJOR ARCHITECTURAL ELEMENTS. AS GRAPHIC DOCUMENTS THE DRAWINGS DO NOT INDICATE OR DESCRIBE THE WORK REQUIRED FOR THE FULL PERFORMANCE AND COMPLETION OF THE CONTRACT DOCUMENTS. ON THE BASIS OF THE GENERAL SCOPE INDICATED OR DESCRIBED THE CONTRACTOR SHALL STUDY THE DRAWINGS AND THEIR GENERAL INFERENCE TO FURNISH THE ITEMS REQUIRED FOR THE PROPER EXECUTION AND COMPLETION OF THE WORK.
  - F. ALL DESIGN TEAM DRAWINGS SHALL BE USED TO LOCATE BUILDING ELEMENTS. CONTACT THE ARCHITECT WITH CONFLICTS, DESCREPANCIES, AND OMISSIONS PRIOR TO COMMENCEMENT OF WORK. WRITTEN DOCUMENTATION SHALL BE PROVIDED BY CONTRACTOR REGARDING SUCH ITEMS.
  - G. ALL IN-WALL BLOCKING IS TO BE FIRE TREATED AS REQUIRED BY CODE.
  - H. CONTRACTOR TO ENSURE ALL WALLS TO MEET FIRE SAFETY REQUIREMENTS WHERE NECESSARY. REFER TO A001 FOR WALL TYPE DETAILS.
  - WALLS TO BE DRYWALLED, TAPED, PAINTED, AND READY FOR NEW FINISH.

    J. BUILDING STANDARD FINISH CEILINGS FURNISHED AND INSTALLED IN ALL

ALL EXISTING COLUMNS, INTERIOR AND EXTERIOR WALLS, AND WINDOW

- SPACES INCLUDING DRYWALL WINDOW POCKET. IF TENANT ELECTS TO HAVE NON-STANDARD FINISHES, IT SHALL RECEIVE A CREDIT FROM LANDLORD EQUAL TO AN AMOUNT THE BUILDING STANDARD FINISH WOULD COST.

  K. COMPLETE WINDOW INSTALLATION WITH DRYWALL, BUILDING STANDARD
- TRIM, SILLS, AND HARDWARE. PROVIDE BUILDING STANDARD WINDOW TREATMENT.
- L. ELECTRICAL SERVICES SHALL BE DISTRIBUTED TO THE JUNCTION BOX/MAIN BREAKER.

## **FLOOR PLAN LEGEND**



FURTHER INFORMATION.

AREA NOT IN PROJECT SCOPE

## REFERENCE PLAN NOTES

- NEW ALUMINUM COMPOSITE PANEL COLUMN COVER BETWEEN EXISTING CONCRETE BASE AND CAPITAL. REPAINT CONCRETE BASE AND CAPITAL , P5. REFER TO FINISH SCHEDULE FOR FURTHER
- 2 REPAINT CONCRETE BASE AND CAPITAL AND COLUMN, P4. REFER TO FINISH SCHEDULE FOR FURTHER INFORMATION.
   3 NEW EXTERIOR TILE FINISH OVER EXISTING WALL FINISH. TILES TO BE SOLID 2' X 4' PHENOLIC
- PANELS ON 3/4" METAL HAT CHANNELS. COLOR TBD. ALL FASTENERS TO BE CONCEALED.
  REFERENCE INTERIOR ELEVATIONS.

  4 REPAINT EXISTING CONCRETE CURB, P6. REFER TO FINISH SCHEDULE FOR FURTHER INFORMATION.
  5 EXISTING SKYLIGHT SYSTEM ABOVE, WITH NEW PAINTED GYP. BD. AND METAL FRAMED BULKHEAD
  7 EXISTING DRIVE SURFACE TO RECEIVE NEW FINISH, CF1. NOTE: CONTRACTOR TO PROVIDE MOCKUPS
  OF 3 COLORS FOR OWNER REVIEW AND FINAL COLOR SELECTION. REFER TO FINISH SCHEDULE FOR
- 8 NEW SUSPENDED LINEAR METAL CEILING WITH LED LIGHTING ABOVE, REFER TO REFLECTED CEILING PLAN
  9 ANGLE PHENOLIC PANEL AT ALL OUTSIDE CORNERS FOR SOLID CORNER.
- NEW CONCRETE RAMP ADA ACCESSIBLE AND NEW GUARD AND HANDRAIL. HANDRAIL TO BE PAINTED P9.
   TURN PHENOLIC PANEL BACK TO EXISTING FINISH TO HIDE FURRING GAP.
- 12 TORN PHENOLIC PANEL BACK TO EXISTING FINISH TO HIDE FORRING GAP.

  13 NEW PAINT FINISH P3. REFER TO FINISH SCHEDULE FOR FURTHER INFORMATION.

  14 EXISTING BRICK PAVERS TO RECEIVE INDUSTRIAL STRENGTH, CHEMICAL CLEANING TREATMENT,
- TYP.

  15 EXISTING CONCRETE STRIPS TO RECEIVE NEW FINISH, CF2. REFER TO FINISH SCHEDULE FOR
- 16 EXISTING CONCRETE STRIPTO RECEIVE NEW FINISH, CF3, AND REFLECTIVE WHITE STRIPING. REFER TO FINISH SCHEDULE FOR FURTHER INFORMATION.
- NEW BRICK PAVER STEPS WITH INTEGRAL LINEAR LED STEP LIGHTING
   NEW CUSTOM COLOR PAINT FINISH AT CONCRETE PIER. REFER TO FINISH SCHEDULE FOR FURTHER INFORMATION.
- 19 NEW 12' X 55' VINYL GRAPHIC BANNER ON ALUMINUM FRAME SYSTEM ON EXISTING STEEL COLUMNS, V.I.F.
   20 NEW SIGNAGE, GRAPHICS AND WAYFINDING
- NEW LIT STAINLESS STEEL BOLLARD
  PATCH AND REPAIR EXISTING CONCRETE RAMP AND APPLY NEW PEDESTRIAN TRAFFIC COATING, CF3

NAME	MANUFACTURER	COLOR	COMMENTS
ONCRETE FIN	IISH		
F1	TREMCO VULKEM EWS PUMA	GRAY, SLATE GRAY, CHARCOAL	DRIVE AND RAMP COATING
F2	RES-TEK		CONCRETE PAVER COATING
F3	RES-TEK		CONCRETE PAVER COATING
XTERIOR HIG	H-PRESSURE COMPACT LAM	INATE	
₽1	TRESPA	DARK / BLACK (TBD)	
P2	TRESPA	WHITE	
AINT			
1	SHERWIN-WILLIAMS	MEDIUM GRAY	ALL EXPOSED DECK, STRUCTURE, AND HVAC
2	SHERWIN-WILLIAMS	WHITE	BULKHEAD GYPSUM BOARD CEILINGS
3	SHERWIN-WILLIAMS	WHITE	EXISTING WALLS
4	SHERWIN-WILLIAMS	TBD	EXISTING INTERIOR COLUMN
5	SHERWIN-WILLIAMS	TBD	EXISTING EXTERIOR COLUMNS
3	SHERWIN-WILLIAMS	YELLOW	EXISTING CONCRETE CURB AT WALKWAY STEPS & ADJACENT COLUMN
7	SHERWIN-WILLIAMS	TBD	MOTOR COURT ENTRY GYPSUM BOARD CEILINGS
3	SHERWIN-WILLIAMS	TBD	ENTRY RAMP ALCOVES
9	SHERWIN-WILLIAMS	TBD	PEDESTRIAN WALKWAY RAILINGS

SHERWIN-WILLIAMS TBD



10 W MARKET ST SUITE 800 INDIANAPOLIS, IN 46204 P: 317.614.0053 F: 317.632.3662 DKGRAR.COM

OWNER
CLAYPOOL COURT LLC
225 W WASHINGTON
INDIANAPOLIS, IN 46204

GENERAL CONTRACTOR
PEPPER CONSTRUCTION

1850 W 15TH STREET
INDIANAPOLIS, IN 46202

SHEET REVISIONS

DESCRIPTION



## ENTRY RENOVATION

110 W WASHINGTON ST INDIANAPOLIS, IN 46204

DATE: 04 MAY 2022 PROJECT #: 2018\_018



THIRD FLOOR REFERENCE PLAN

SHEET NO

4101

## **ELEVATION NOTES**

- 1 NEW BRAND/GARAGE ENTRANCE SIGNAGE TO REPLACE EXISTING SIGNAGE
- 2 NEW INTERALLY ILLUMINATED EMBASSY SUITES SIGNAGE, PER BRAND APPROVAL 3 EXTERIOR CLADDING PANEL, WITH CONCEALED FIXING SYSTEM ON RAILS ON EXISTING STONE
- CLADDING PANELS, SIMILAR TO TRESPA METEON DIFFUSE, EP1. 4 EXTERIOR EXTRUDED ALUMINUM FIN SYSTEM WITH TOP AND BOTTOM EXTRUDED RAILS, ALL EXTRUSIONS POWDER COATED, SIMILAR TO AMERICAN PRODUCTS INC. EXTERIOR FIN SYSTEM. INTEGRAL PROGRAMMABLE RGB LED COVE LIGHTING WITHIN FIN SYSTEM, PROVIDE BLOCKING AND
- POWER AS REQUIRED. 6 EXTERIOR CLADDING PANEL, WITH CONCEALED FIXING SYSTEM ON RAILS ON EXISTING STONE CLADDING PANELS, SIMILAR TO TRESPA METEON SPECULAR, EP2. 7 CONTINUOUS 1 1/2" DIA. ANODIZED ALUMINUM HANDRAIL WITH POST MOUNTED HANDRAIL SADDLE BRACKET. PROVIDE KLUS B6144ANODA POR EXTURUSION OR EQUAL AND LED LIGHT TAPE AND LENS
- CONTINUOUS IN HANDRAIL BETWEEN THE SADDLE BRAKCETS. 8 NEW BRICK PAVER STEPS WITH INTEGRAL LINEAR LED STEP LIGHTING 9 NEW POURED IN PLACE CONCRETE CURB, TO MATCH PROFILE OF EXISTING ADJACENT CONCRETE CURB. PAINT P10
- 10 CONTINUOUS LENS LED LIGHT, L5
  11 ALUMINUM TRIM END CAP, TO MATCH EP1 12 NEW EXTRUDED ALUMINUM BAFFLE SYSTEM 15" DEEP, POWDERCOATED, SIMILAR TO AMERICAN PRODUCTS INC. LINEAR CEILING BEAM SYSTEM, ON UNISTRUCT WITH HANGER BRACKETS AND THREADED ROD TO EXISTING STRUCTURE AS REQUIRED.
- 13 NEW PREFINISHED METAL COPING OVER EXISTING PARAPET. NEW FRT NAILER AS NEEDED TO PROVIDE CONTINUOUS ATTACHMENT OF NEW COPING. 14 ALUMINUM EXTRUSION, SIMILAR TO KLUS PDS 4-ALU, WITH WET-LISTED LED TAPE AND REMOTE-MOUNT
- 15 BRICK PAVER, MATCH EXISTING



UKGr

10 W MARKET ST SUITE 800

P: 317.614.0053

F: 317.632.3662

DKGRAR.COM

INDIANAPOLIS, IN 46204

CLAYPOOL COURT LLC

PEPPER CONSTRUCTION

225 W WASHINGTON INDIANAPOLIS, IN 46204

GENERAL CONTRACTOR

1850 W 15TH STREET INDIANAPOLIS, IN 46202




# **ENTRY** RENOVATION

110 W WASHINGTON ST INDIANAPOLIS, IN 46204

DATE: 04 MAY 2022 PROJECT #: 2018\_018



**EXTERIOR ELEVATIONS** 

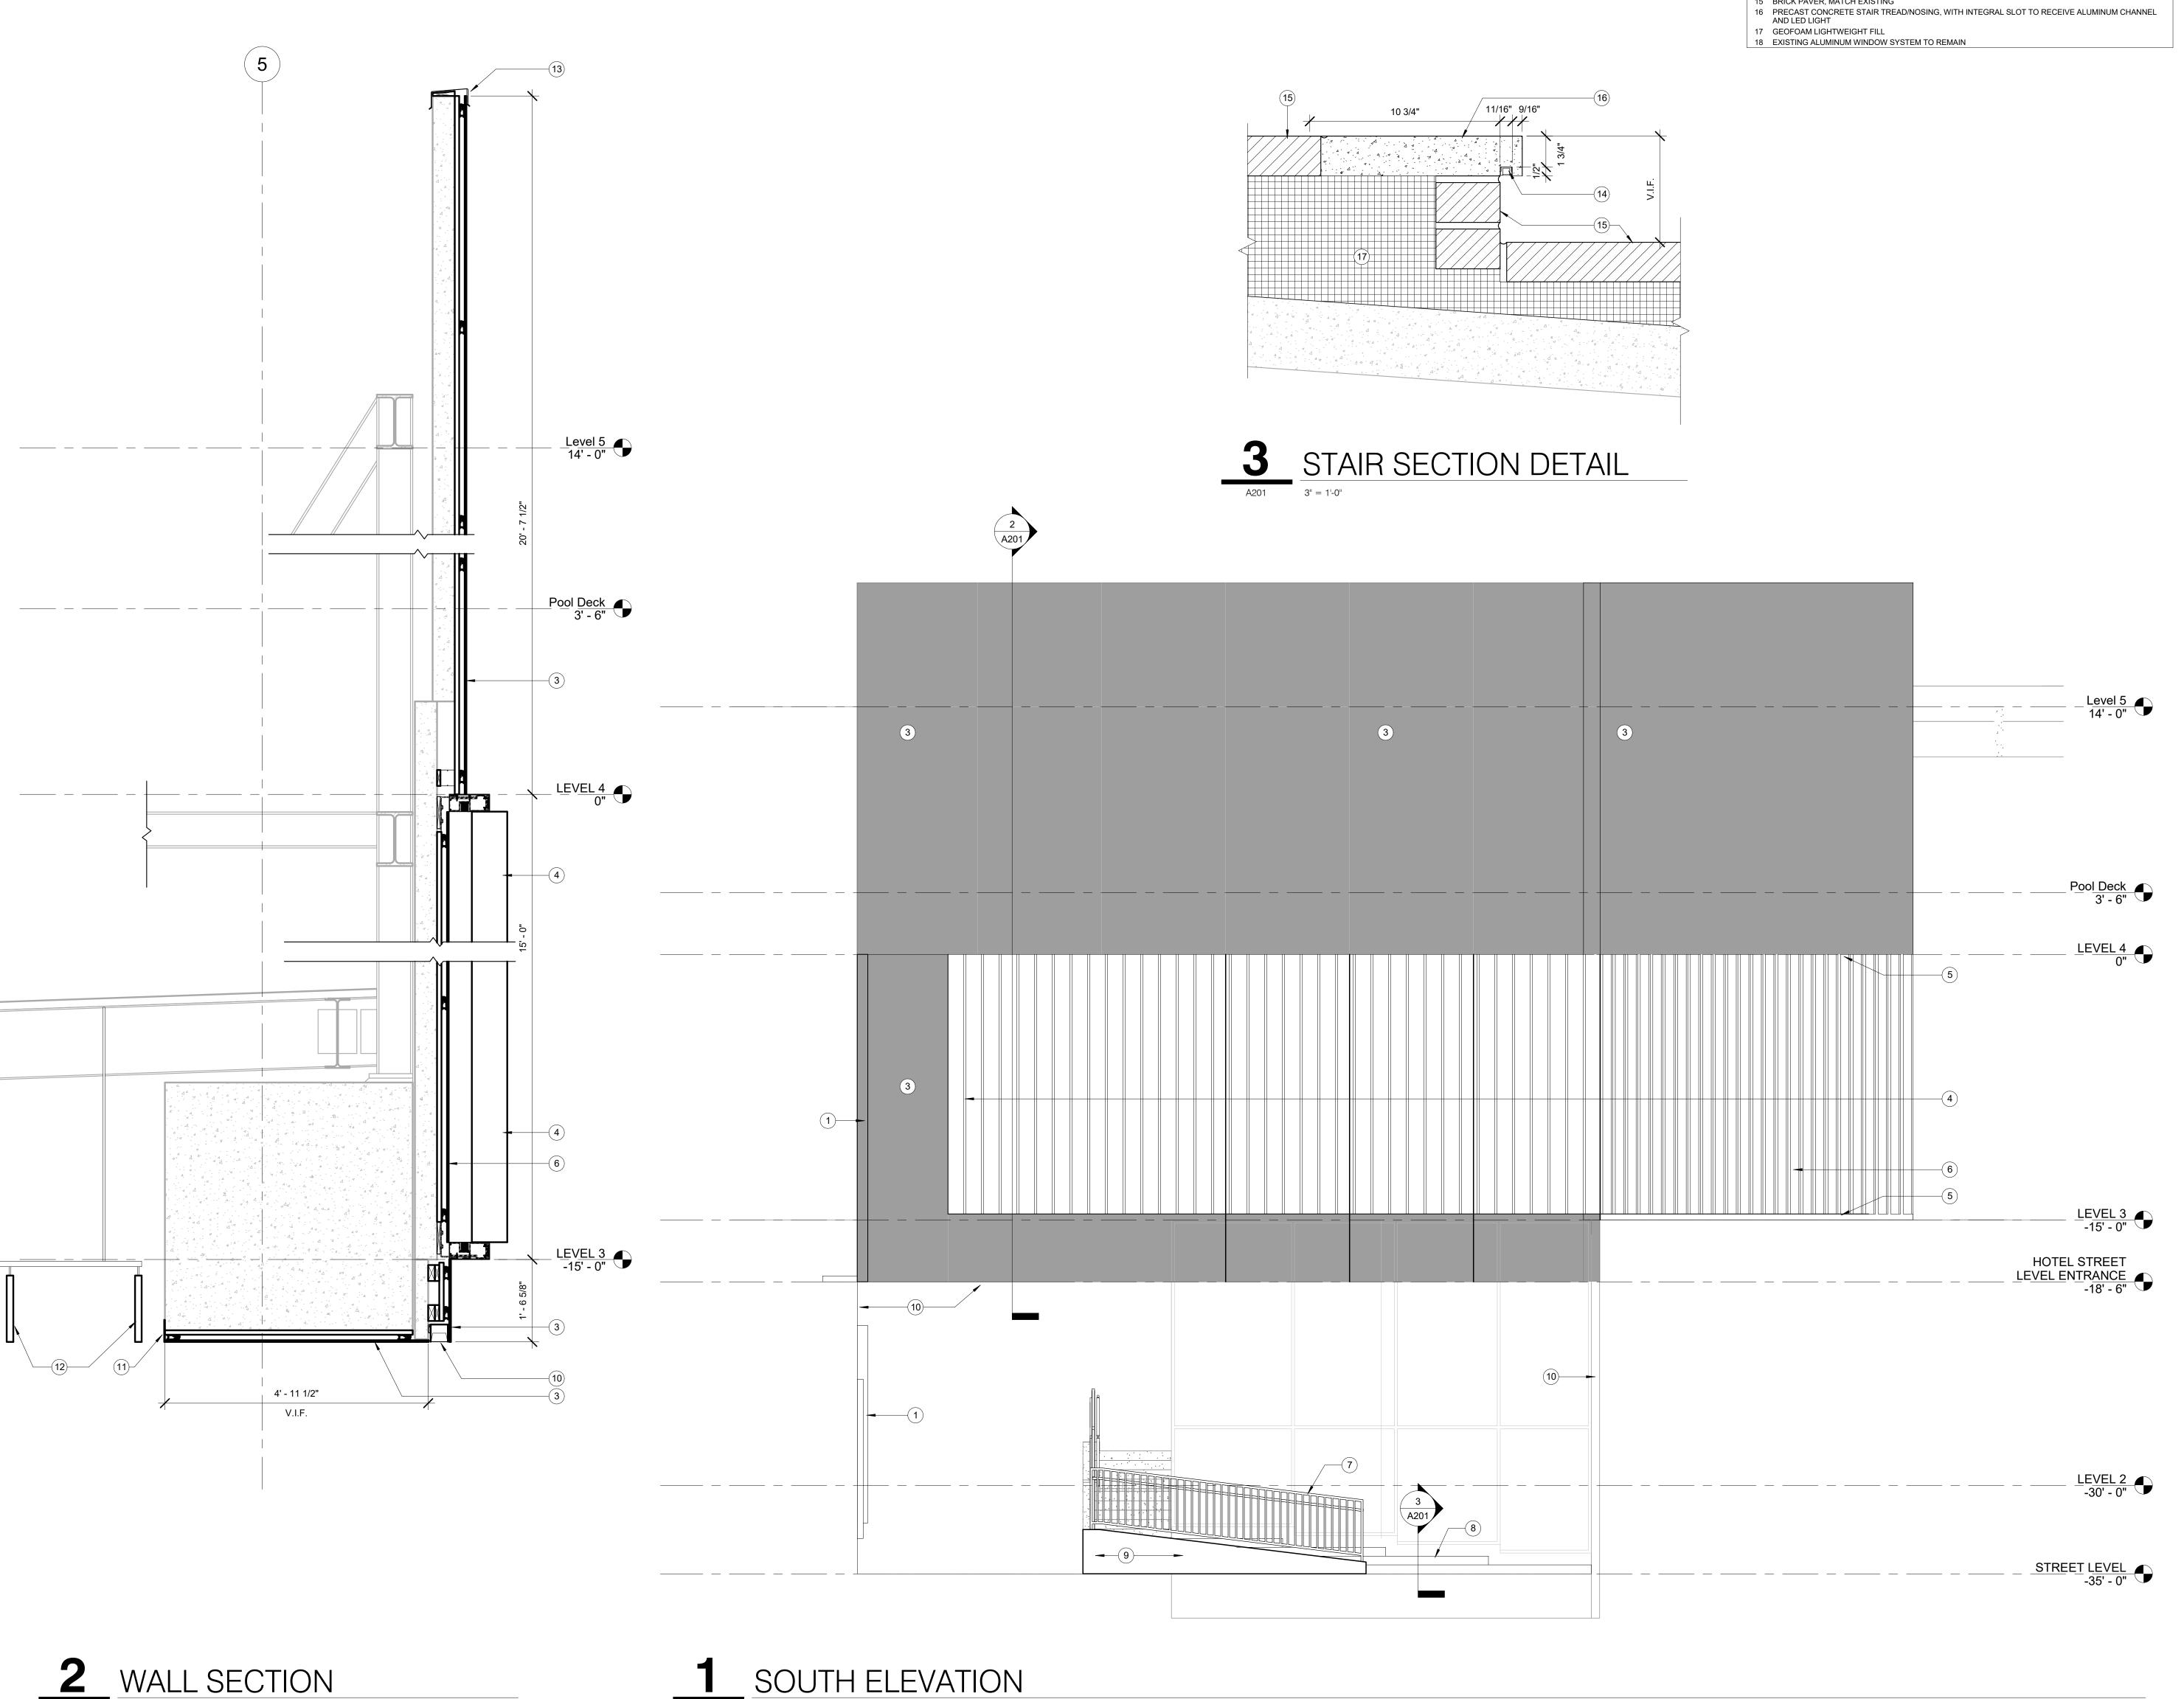

SOUTH ELEVATION

## **ELEVATION NOTES**

- 1 NEW BRAND/GARAGE ENTRANCE SIGNAGE TO REPLACE EXISTING SIGNAGE
- 2 NEW INTERALLY ILLUMINATED EMBASSY SUITES SIGNAGE, PER BRAND APPROVAL 3 EXTERIOR CLADDING PANEL, WITH CONCEALED FIXING SYSTEM ON RAILS ON EXISTING STONE
- CLADDING PANELS, SIMILAR TO TRESPA METEON DIFFUSE, EP1. 4 EXTERIOR EXTRUDED ALUMINUM FIN SYSTEM WITH TOP AND BOTTOM EXTRUDED RAILS, ALL EXTRUSIONS POWDER COATED, SIMILAR TO AMERICAN PRODUCTS INC. EXTERIOR FIN SYSTEM.
- 5 INTEGRAL PROGRAMMABLE RGB LED COVE LIGHTING WITHIN FIN SYSTEM, PROVIDE BLOCKING AND POWER AS REQUIRED. 6 EXTERIOR CLADDING PANEL, WITH CONCEALED FIXING SYSTEM ON RAILS ON EXISTING STONE CLADDING PANELS, SIMILAR TO TRESPA METEON SPECULAR, EP2.
- 7 CONTINUOUS 1 1/2" DIA. ANODIZED ALUMINUM HANDRAIL WITH POST MOUNTED HANDRAIL SADDLE BRACKET. PROVIDE KLUS B6144ANODA POR EXTURUSION OR EQUAL AND LED LIGHT TAPE AND LENS CONTINUOUS IN HANDRAIL BETWEEN THE SADDLE BRAKCETS.
- 8 NEW BRICK PAVER STEPS WITH INTEGRAL LINEAR LED STEP LIGHTING 9 NEW POURED IN PLACE CONCRETE CURB, TO MATCH PROFILE OF EXISTING ADJACENT CONCRETE CURB. PAINT P10 10 CONTINUOUS LENS LED LIGHT, L5
- 11 ALUMINUM TRIM END CAP, TO MATCH EP1 12 NEW EXTRUDED ALUMINUM BAFFLE SYSTEM 15" DEEP, POWDERCOATED, SIMILAR TO AMERICAN PRODUCTS INC. LINEAR CEILING BEAM SYSTEM, ON UNISTRUCT WITH HANGER BRACKETS AND THREADED ROD TO EXISTING STRUCTURE AS REQUIRED.
- 13 NEW PREFINISHED METAL COPING OVER EXISTING PARAPET. NEW FRT NAILER AS NEEDED TO PROVIDE CONTINUOUS ATTACHMENT OF NEW COPING. 14 ALUMINUM EXTRUSION, SIMILAR TO KLUS PDS 4-ALU, WITH WET-LISTED LED TAPE AND REMOTE-MOUNT
- 15 BRICK PAVER, MATCH EXISTING
- 16 PRECAST CONCRETE STAIR TREAD/NOSING, WITH INTEGRAL SLOT TO RECEIVE ALUMINUM CHANNEL AND LED LIGHT
- 17 GEOFOAM LIGHTWEIGHT FILL 18 EXISTING ALUMINUM WINDOW SYSTEM TO REMAIN




10 W MARKET ST SUITE 800 INDIANAPOLIS, IN 46204 P: 317.614.0053 F: 317.632.3662


DKGRAR.COM


CLAYPOOL COURT LLC 225 W WASHINGTON INDIANAPOLIS, IN 46204

GENERAL CONTRACTOR PEPPER CONSTRUCTION 1850 W 15TH STREET INDIANAPOLIS, IN 46202

SHEET REVISIONS				
#	DESCRIPTION	DATE		
5	ASI 03	2022-10-26		

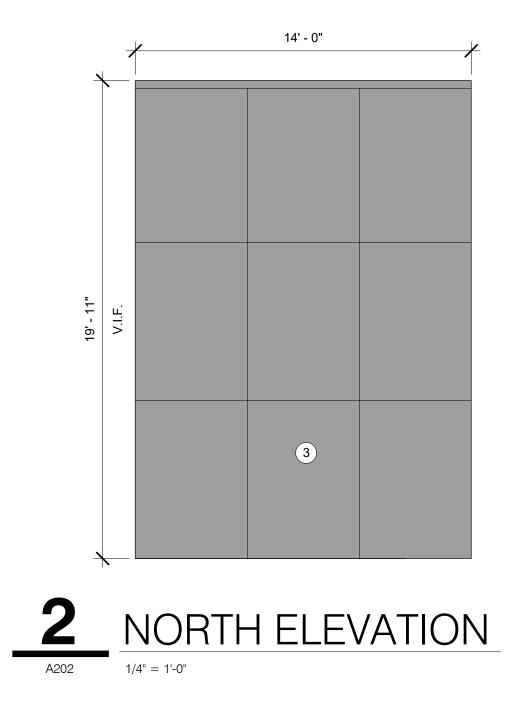

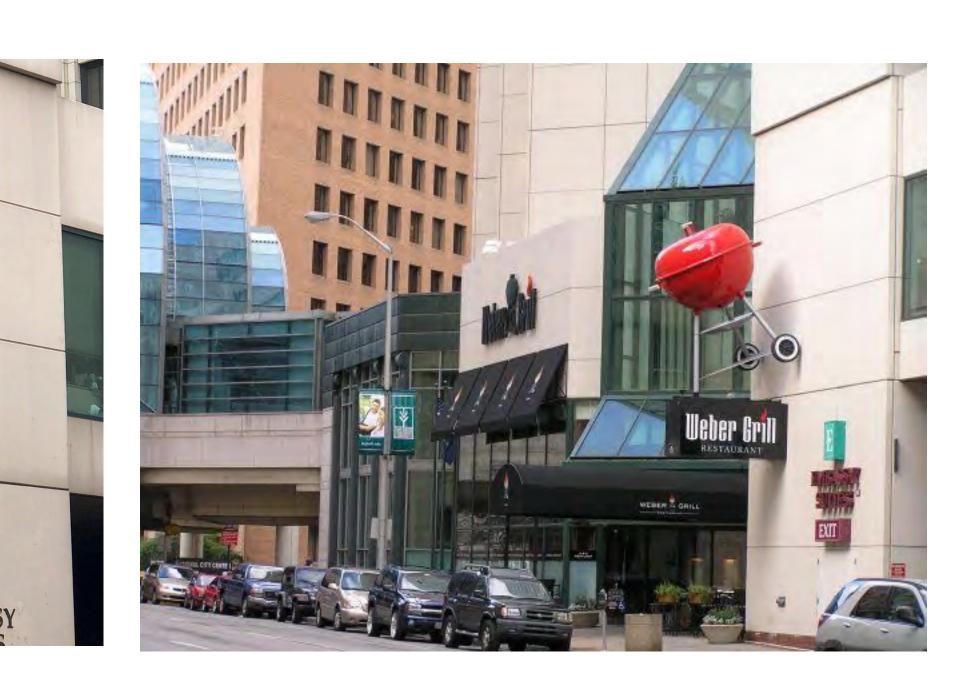

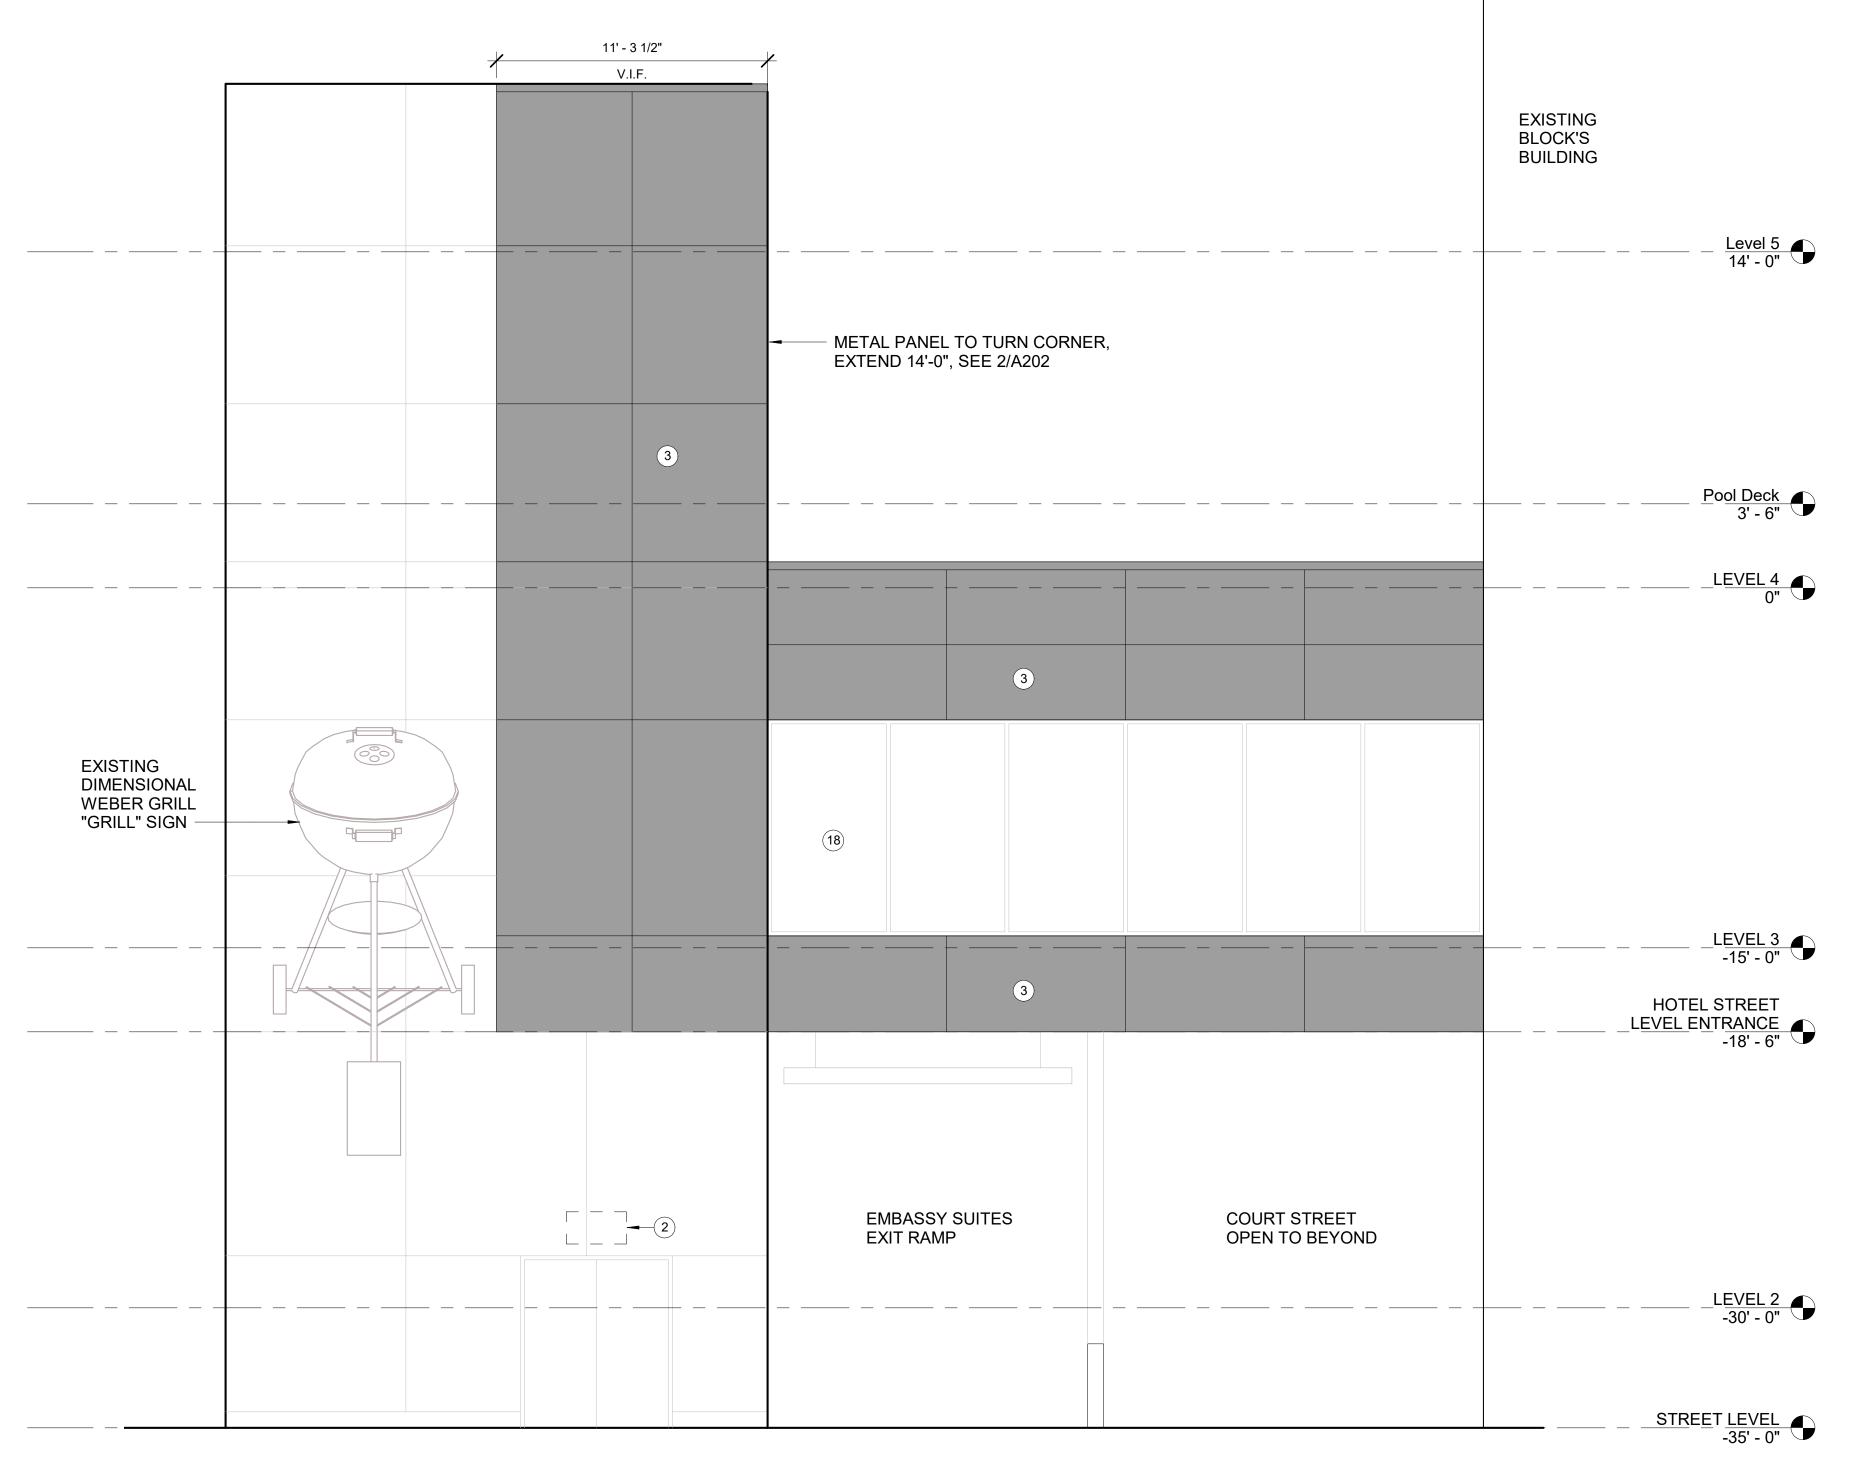

EAST ELEVATION

**EXTERIOR** 

**ELEVATIONS** 

EMBASSY

SUITES

by **HILTON**™

RENOVATION


110 W WASHINGTON ST INDIANAPOLIS, IN 46204

No. 10500156

**ENTRY** 

DATE: 04 MAY 2022

PROJECT #: 2018\_018

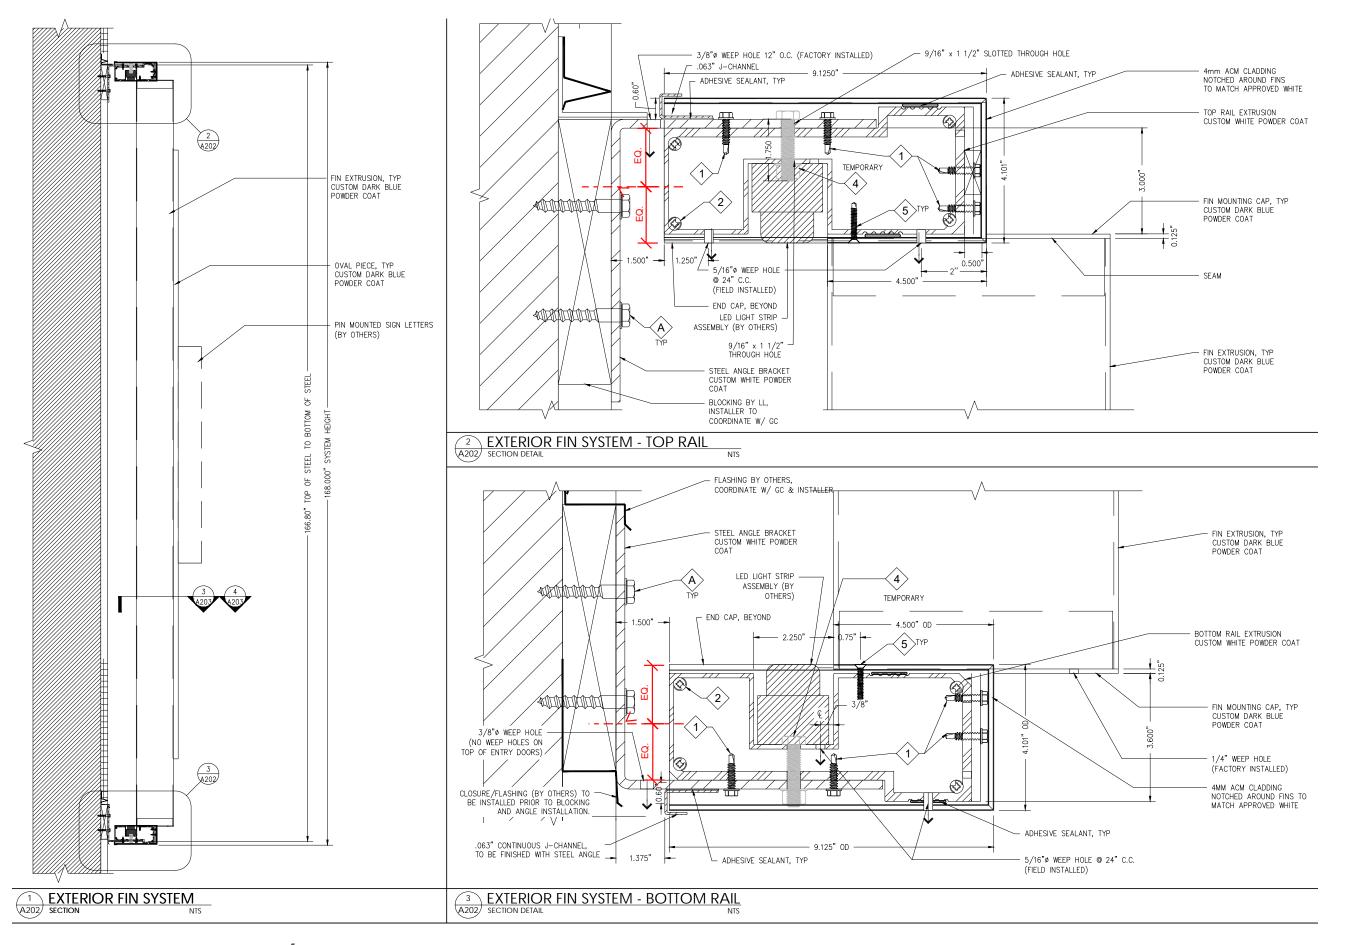








The area surround the vertical fin system will be black metal panel, similar to adjacent Tony's restaurant exterior. Vertical aluminum extrusion fins at Embassy Suites and Court Street garage exterior will be white, with white metal panel beyond. Horizontal aluminum channels at the top and bottom of the vertical fins will host linear RGBW lighting strips, (similar to backlit panels at adjacent Tony's restaurant) that will slowly gradate between various colors. Maximum speed between alternating colors will be 5 seconds. There will no flashing or other lighting effects.





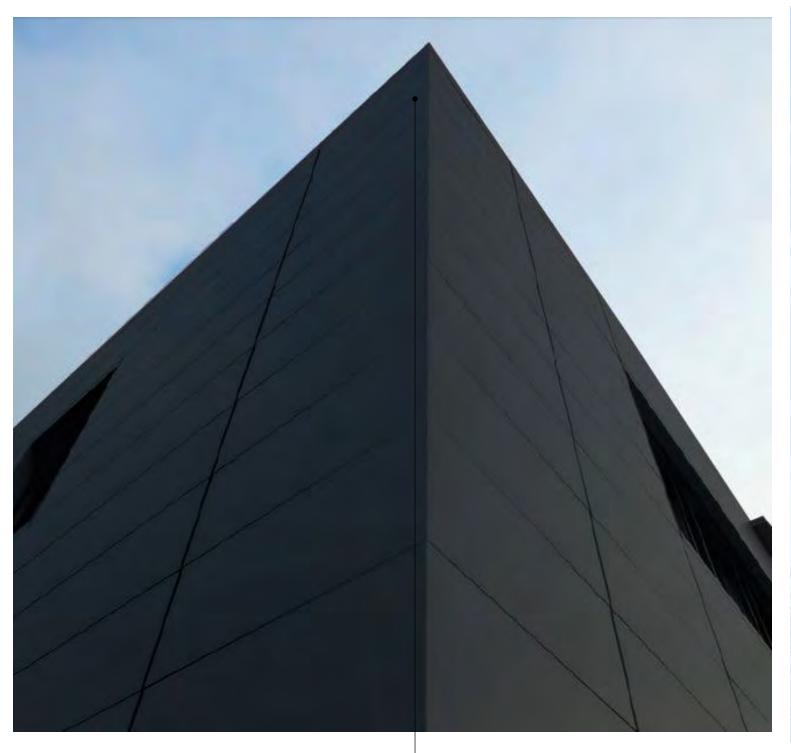



The area surround the vertical fin system will be black metal panel, similar to adjacent Tony's restaurant exterior.

Facade behind the vertical aluminum white fins will be white metal panel, to be surface lit from above and below with continuous RGBW LED lighting.







